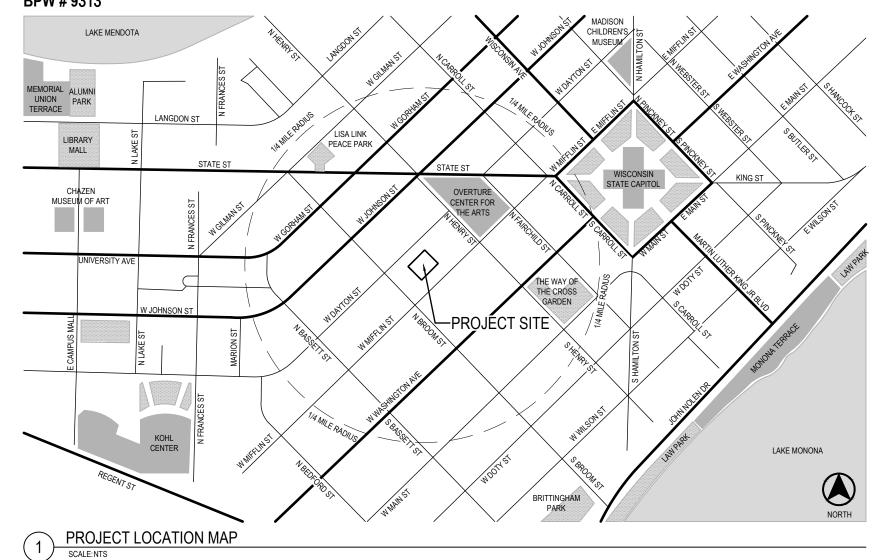
MADISON SENIOR CENTER COURTYARD

330 WEST MIFFLIN STREET

MADISON, WI 53703

MUNIS # 12728-51-130 BPW # 9313



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T000 - TITLE SHEET

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PROJECT INFORMATION

CLIENT

CITY OF MADISON PARKS DIVISION 330 E. LAKESIDE STREET MADISON, WI 53715 CONTACT: MIKE STURM 608.267.4921

PRIME CONSULTANT / LANDSCAPE ARCHITECT SAIKI DESIGN, INC.

SAIN DESIGN, INC. 1110 S. PARK ST MADISON, WI 53715 CONTACT: ABBIE MOILIEN 608.405.8149



CIVIL ENGINEER

BURSE SURVEYING & ENGINEERING 2801 INTERNATIONAL LN | SUITE 101 MADISON, WI 53704 CONTACT: MICHELLE BURSE 608.250.9263

STRUCTURAL & ELECTRICAL ENGINEER MEAD & HUNT

2440 DEMING WAY MIDDLETON, WI 53562 CONTACT: MARK STIFTER 608.443.0561





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- ALL PRIVATE UTILITIES (GAS, ELECTRIC, AND TELECOMMUNICATIONS) SERVING EXISTING BUILDINGS OR STRUCTURES SCHEDULED FOR DEMOLITION TO BE ABANDONED OR REMOVED BY CORRESPONDING UTILITY COMPANY. CONTRACTOR SHALL CONTACT EACH PRIVATE UTILITY COMPANY TO COORDINATE THE INFRASTRUCTURE REMOVAL.
- 2. IT IS THE CONTRACTOR'S RESPONSIBILITY TO VERIFY THE LOCATION OF UNDERGROUND UTILITIES. UTILITIES WERE LOCATED BY OBSERVED EVIDENCE, MARKINGS PROVIDED BY DIGGER'S HOTLINE
- 3. CONTRACTOR SHALL VERIFY THE SIZE, TYPE, SLOPE, AND INVERTS OF ALL EXISTING STORM STRUCTURES CALLED OUT TO BE CONNECTED TO. CONTRACTOR SHALL SUBMIT THE INFORMATION ON THE STRUCTURES TO THE CITY PROJECT MANAGER AND PROJECT CIVIL ENGINEER.
- 4. ANY SIDEWALK, CURB, OR OTHER PUBLIC PROPERTY DAMAGED AS PART OF THE CONSTRUCTION OF THE UTILITIES AND BUILDING SHALL BE REPLACED IN-KIND PER THE CITY OF MADISON STANDARD SPECIFICATIONS.
- 5. THE RIGHT-OF-WAY IS THE SOLE JURISDICTION OF THE CITY OF MADISON AND IS SUBJECT TO CHANGE AT ANY TIME PER THE RECOMMENDATION/PLAN OF THE CITY.

SITE REMOVAL NOTES:

- 1. THE CONTRACTOR IS RESPONSIBLE FOR THE DEMOLITION, REMOVAL, AND DISPOSING IN A LOCATION APPROVED BY ALL GOVERNING AUTHORITIES, OF ALL STRUCTURES, PADS, WALLS, FLUMES, FOUNDATIONS, PARKING DRIVES, DRAINAGE, STRUCTURES, UTILITIES, ETC., SUCH THAT THE IMPROVEMENTS SHOWN ON THE REMAINING PLANS CAN BE CONSTRUCTED. ALL FACILITIES TO BE REMOVED SHALL BE UNDERCUT TO SUITABLE MATERIAL AND BROUGHT TO GRADE WITH SUITABLE COMPACTED FILL MATERIAL PER THE PLANS AND SPECIFICATIONS.
- 2. THE CONTRACTOR IS RESPONSIBLE FOR OBTAINING ALL PERMITS REQUIRED FOR DEMOLITION AND DISPOSAL.
- 3. THE CONTRACTOR SHALL COORDINATE WITH THE RESPECTIVE UTILITY COMPANIES PRIOR TO THE REMOVAL AND/OR RELOCATION OF UTILITIES. THE CONTRACTOR SHALL COORDINATE WITH THE UTILITY COMPANY CONCERNING PORTIONS OF WORK WHICH MAY BE PERFORMED BY THE UTILITY COMPANY FORCING ANY FRES WHICH ARE TO BE PAID TO THE UTILITY COMPANY FOR THEIR SERVICES. THE DEVELOPER IS RESPONSIBLE FOR PAYING ALL FEES AND CHARGES.
- 4. THE LOCATIONS OF ALL EXISTING UTILITIES SHOWN ON THIS PLAN HAVE BEEN DETERMINED FROM THE BEST INFORMATION AVAILABLE AND ARE GVEN FOR THE CONVENIENCE OF THE CONTRACTOR. THE ENGINEER ASSUMES NO RESPONSIBILITY FOR THEIR ACCURACY. PRIOR TO THE START OF ANY DEMOLITION ACTIVITY, THE CONTRACTOR SHALL NOTIFY THE UTILITY COMPANIES FOR ONSITE LOCATIONS OF EXISTING UTILITIES. NOTIFY THE ENGINEER OF ANY DISCREPANCIES.
- 5. ALL EXISTING SEWERS, PIPING, AND UTILITIES SHOWN ARE NOT TO BE INTERPRETED AS THE EXACT LOCATION, OR AS THE ONLY OBSTACLES THAT MAY OCCUR ON THE SITE. VERIFY EXISTING CONDITIONS AND PROCEED WITH CAUTION AROUND ANY ANTICIPATED FEATURES. GVE NOTICE TO ALL UTILITY COMPANIES REGARDING DESTRUCTION AND REMOVAL OF ALL SERVICE LINES BEFORE PROCEEDING WITH THE WORK. UTILITIES DETERMINED TO BE ABANDONED AND LEFT IN PLACE SHALL BE GROUTED IF UNDER BUILDINGS.
- 6. ELECTRICAL, TELEPHONE, CABLE, WATER, FIBER OPTIC CABLE, AND/OR GAS LINES NEEDING TO BE REMOVED OR RELOCATED SHALL BE COORDINATED WITH THE AFFECTED UTILITY COMPANY. ADEQUATE TIME SHALL BE PROVIDED FOR RELOCATION AND CLOSE COORDINATION WITH THE UTILITY COMPANY IS NECESSARY TO PROVIDE A SMOOTH TRANSITION IN UTILITY SERVICE.
- 7. CONTRACTOR SHALL PROTECT THE PUBLIC AT ALL TIMES WITH FENCING, BARRICADES, ENCLOSURES, COVERED WALKWAYS, ETC. CONTRACTOR SHALL SUBMIT THEIR STREET OCCUPANCY PLAN TO TRAFFIC ENGINEERING FOR APPROVAL.
- 8. PRIOR TO DEMOLITION OCCURRING, ALL APPLICABLE EROSION CONTROL DEVICES ARE TO BE INSTALLED.
- 9. THE CONTRACTOR MAY LIMIT SAWCUT AND PAVEMENT REMOVAL TO ONLY THOSE AREAS WHERE IT IS REQUIRED AS SHOWN ON THESE CONSTRUCTION PLANS, BUT IF ANY DAMAGE IS INCURRED ON ANY OF THE SURROUNDING PAVEMENT, ETC. THE CONTRACTOR SHALL BE RESPONSIBLE FOR ITS REMOVAL AND REPAIR IN KIND.
- 10. DAMAGE TO ALL EXISTING CONDITIONS TO REMAIN WILL BE REPLACED AT THE CONTRACTOR'S EXPENSE.
- 11. CONTINUOUS ACCESS SHALL BE MAINTAINED FOR THE SURROUNDING PROPERTIES AT ALL TIMES DURING DEMOLITION OF THE EXISTING FACILITIES.

SITE PLAN NOTES:

1. TRAFFIC CONTROL SIGNAGE SHALL BE IN ACCORDANCE WITH FEDERAL, STATE, COUNTY, CITY, AND LOCAL CODE, WHICHEVER HAS JURISDICTION.

2. CITY SIDEWALK AND CURB DAMAGED IN THE COURSE OF CONSTRUCTION TO BE REPLACED PER CITY OF MADISON STANDARD SPECIFICATIONS.

GRADING PLAN NOTES:

1. ALL GRADES ARE FINISH ELEVATION UNLESS NOTED OTHERWISE.

2. THE LONGITUDINAL SLOPE OF THE NEW CONCRETE SIDEWALK BELOW THE NEW PRECAST SEATWALLS SHALL BE CONSISTENT FOR THE ENTIRE LENGTH OF EACH NEW PRECAST SEATWALL. LONGITUDINAL SLOPES ARE SHOWN ON THE GRADING PLAN.

UTILITY PLAN NOTES:

- 1. ALL WORK WITHIN THE CITY RIGHT OF WAY SHALL BE COMPLIANT WITH THE CITY OF MADISON STANDARD SPECIFICATIONS CURRENT AT THE TIME OF CONSTRUCTION.
- UTILITY INSTALLATION SHALL BE COORDINATED WITH ENGINEER AT LEAST 4 WEEKS PRIOR TO INSTALLATION TO ENSURE BUILDING INSPECTION APPROVAL IS OBTAINED.

STAKING/LAYOUT NOTES

- 1. ALL STAKING CONTROL POINTS SHALL BE PROTECTED THROUGHOUT THE PROJECT.
- 2. STAKING AND LAYOUT FOR THIS PROJECT IS THE RESPONSIBILITY OF THE CONTRACTOR.
- 3. NO STAKING COORDINATES WILL BE PROVIDED FOR THE WORK SHOWN. ELECTRONIC AUTOCAD FILES WILL BE PROVIDED AND IT IS THE CONTRACTOR'S RESPONSIBILITY TO PROVIDE STAKING AND LAYOUT BASED ON ELECTRONIC DRAWING DATA.
- 4. UNLESS OTHERWISE APPROVED, IT IS EXPECTED THAT UTILITY ELEVATIONS ARE CAREFULLY OBTAINED FROM THE PLANS, AND THAT UTILITIES WILL BE INSTALLED AS CLOSE TO PRECISE PROFILE ELEVATIONS AS CONSTRUCTION METHODS WILL REASONABLY ALLOW.

- EROSION CONTROL NOTES/SPECIFICATIONS: 1. EROSION CONTROL DEVICES AND/OR STRUCTURES SHALL BE INSTALLED INCREMENTALLY, AND PROMPTLY, DURING DEMOLITION AND REMOVAL OPERATIONS. THESE SHALL BE PROPERLY MAINTAINED FOR MAXIMUM EFFECTIVENESS UNTIL VEGETATION IS ESTABLISHED.
- 2. EROSION CONTROL IS THE RESPONSIBILITY OF THE CONTRACTOR UNTIL ACCEPTANCE OF THIS PROJECT. EROSION CONTROL MEASURES AS SHOWN SHALL BE THE MINIMUM PRECAUTIONS THAT WILL BE ALLOWED. THE CONTRACTOR SHALL BE RESPONSIBLE FOR RECORNIZING AND CORRECTING ALL EROSION CONTROL PROBLEMS THAT ARE THE RESULT OF CONSTRUCTION ACTIVITIES. ADDITIONAL EROSION CONTROL MEASURES, AS REQUESTED IN WRITING BY THE STATE OR LOCAL INSPECTORS, OR THE PROJECT ENGINEER, SHALL BE INSTALLED WITHIN 24 HOURS.
- 3. ALL EROSION CONTROL MEASURES AND STRUCTURES SERVING THE SITE MUST BE INSPECTED AT LEAST WEEKLY OR WITHIN 24 HOURS OF THE TIME 0.5 INCHES OF RAIN IS PRODUCED. ALL MAINTENANCE MILL FOLLOW AN INSPECTION WITHIN 24 HOURS. INSPECTION SCHEDULE AND RECORD KEEPING SHALL COMPLY WITH NR 216.46(9), WIS. ADM. CODE.
- 4. CONSTRUCTION ENTRANCES PROVIDE A MANUFACTURED TRACKOUT CONTROL PRACTICE AT EACH POINT OF ACCESS. INSTALL ACCORDING TO CONSINCULING ENTRANCES - PROVIDE A MANOPALIDED INACKOUT CONTROL PRACTICE AT EACH POINT OF ACCESS. INSTALL ACCORDING TO WORR STANDARD 1057, REFER TO WORR'S STORMWATER WEB PAGE OF TECHNICAL STANDARDS AT: HTTP://DNR.W.GOV/TOPIC/STORMWATER/STANDARDS/CONST_STANDARDS.HTML. THE CONTROL PRACTICE MUST BE MAINTAINED IN A CONDITION THAT PREVENTS THE TRACKING OF MATERIAL ONTO THE PUBLIC STREET.
- 5. SOIL STOCKPILES A ROW OF SILT SOCK PLACED DOWNSLOPE AND AT LEAST 10 FEET AWAY FROM THE STOCKPILE SHALL PROTECT ALL STOCKPILES. SOIL STOCKPILES THAT ARE INACTIVE FOR MORE THAN 7 CONSECUTIVE DAYS SHALL BE STABILIZED WITH SEED & MULCH, EROSION MAT, POLYMER, OR COVERED WITH TARPS OR SIMILAR MATERIAL NO STOCKPILE SHALL BE PLACED WITHIN 20 FEET OF A DRAINAGE WAY.
- 6. DEWATERING WATER PUMPED FROM THE SITE SHALL BE TREATED BY USING A TEMPORARY SEDIMENTATION BASIN, PORTABLE DEWATERING BASIN, CEOTEXTILE BAG, OR AN EQUIVALENT DEVICE. SHOW ON THE PLAN THE ANTICIPATED LOCATIONS OF DEWATERING ACTIVITY, AND PROVIDE AN ENGINEERING DETAIL OF THE DEWATERING SYSTEM. DEVISES SHALL COMPLY WITH WONR TECHNICAL STANDARD 1061 FOUND AT: HTTE://DNR.W.GCV/TOPIC/STORTWATER/STANDARDS/CONST_STANDARDS.HTML THIS WATER SHALL BE DISCHARGED IN A MANNER THAT DOES NOT INDUCE EROSION OF THE SITE OR ADJACENT PROPERTY.



- STORM SEWER INLETS AND CATCH BASINS PROVIDE RIGID FRAME INLET PROTECTION. INLET PROTECTION SHALL BE INSTALLED PRIOR TO THE STORM SEWER SYSTEM RECEIVING SITE RUNOFF. OTHER THAN FOR PERFORMING MAINTENANCE, THESE DEVICES SHALL NOT BE REMOVED UNTIL PROJECT-LEVEL STABILIZATION IS COMPLETE.
- 8. BUILDING AND WASTE MATERIALS SHALL BE PREVENTED FROM RUNNING-OFF THE SITE AND ENTERING WATERS OF THE STATE IN CONFORMANCE WITH NR151.12(6M).
- 9. NO SOLID MATERIAL SHALL BE DISCHARGED OR DEPOSITED INTO WATERS OF THE STATE IN VIOLATION OF CH. 30 OR 31 OF THE WISCONSIN STATE STATUTES OR 33 USC 1344 PERMITS.
- 10. EROSION CONTROL DEVICES SHALL ADHERE TO THE TECHNICAL STANDARDS FOUND AT: http://dnr.wi.gov/runoff/stormwater/techstds.htm AND COMPLY WITH ALL CITY OF MADISON CHAPTER 37 ORDINANCES AND STANDARD SPECIFICATIONS.
- 11. ALL DEBRIS TRACKED ONTO PUBLIC STREETS SHALL BE BE SWEPT OR SCRAPED CLEAN BY THE END OF EACH WORKDAY. 12. ALL BUILDING AND WASTE MATERIAL SHALL BE HANDLED PROPERLY TO PREVENT RUNOFF OF THESE MATERIALS OFF OF THE SITE.
- 13. IMMEDIATELY STABILIZE ALL FINE-GRADED DISTURBED AREAS THAT WILL REMAIN INACTIVE FOR 14 DAYS OR LONGER WITH DENSE GRADED BASE, SOD, PLANTINGS, OR SOIL TACKIFIER.





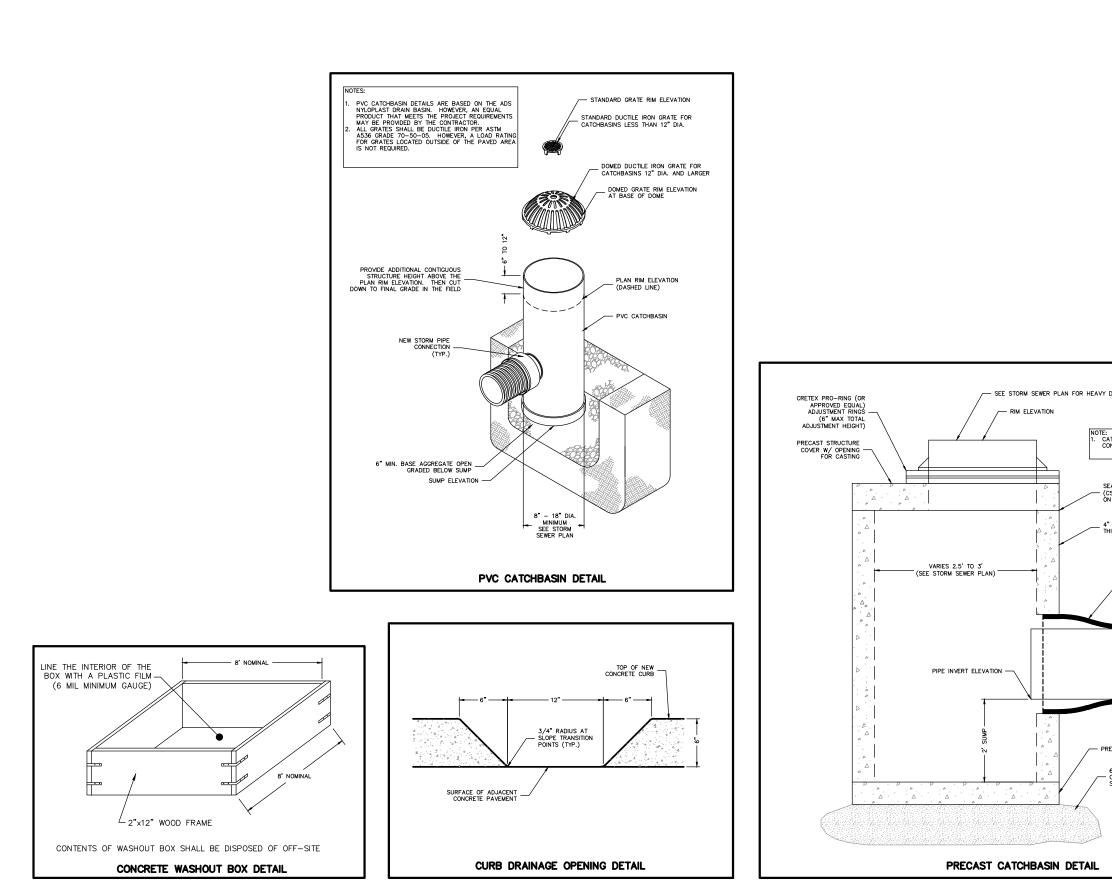
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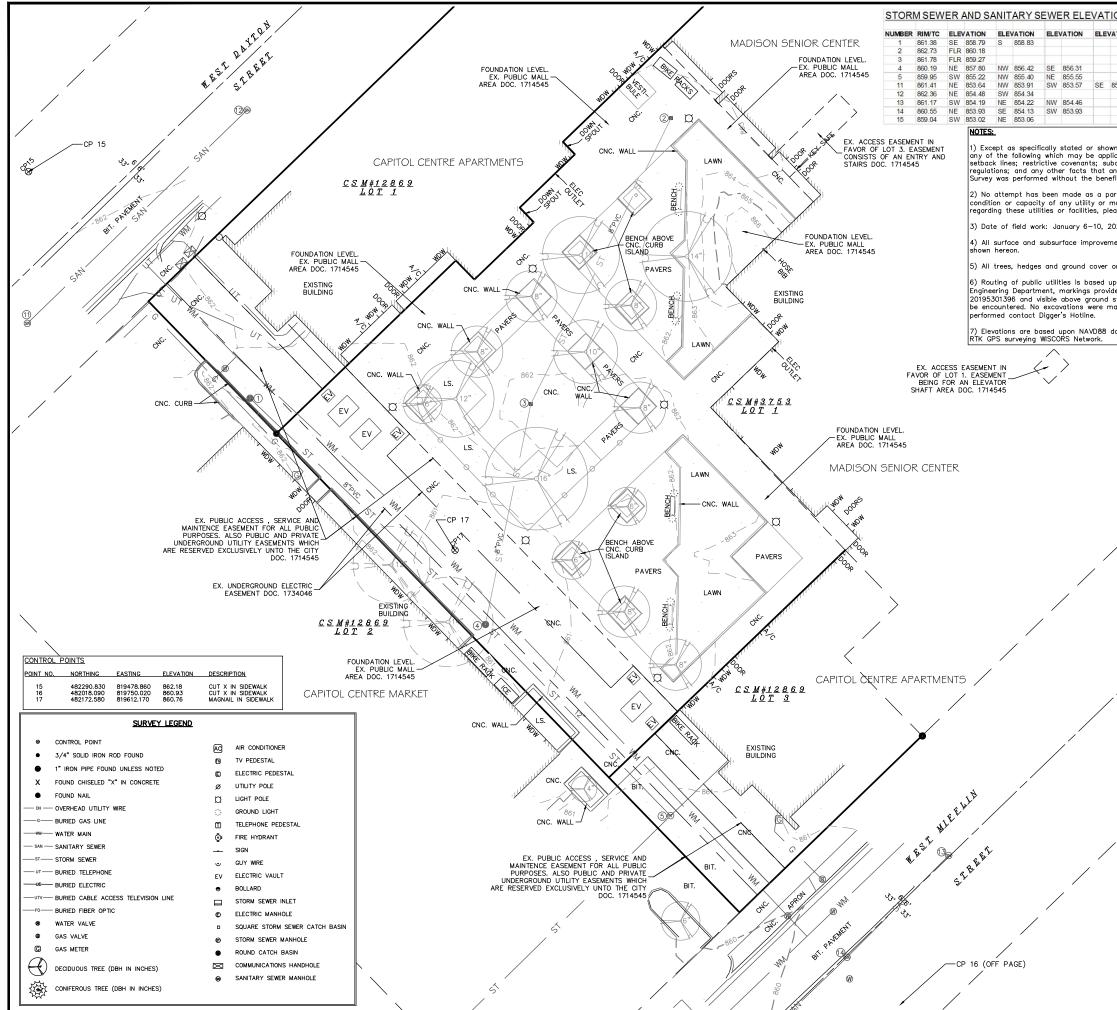
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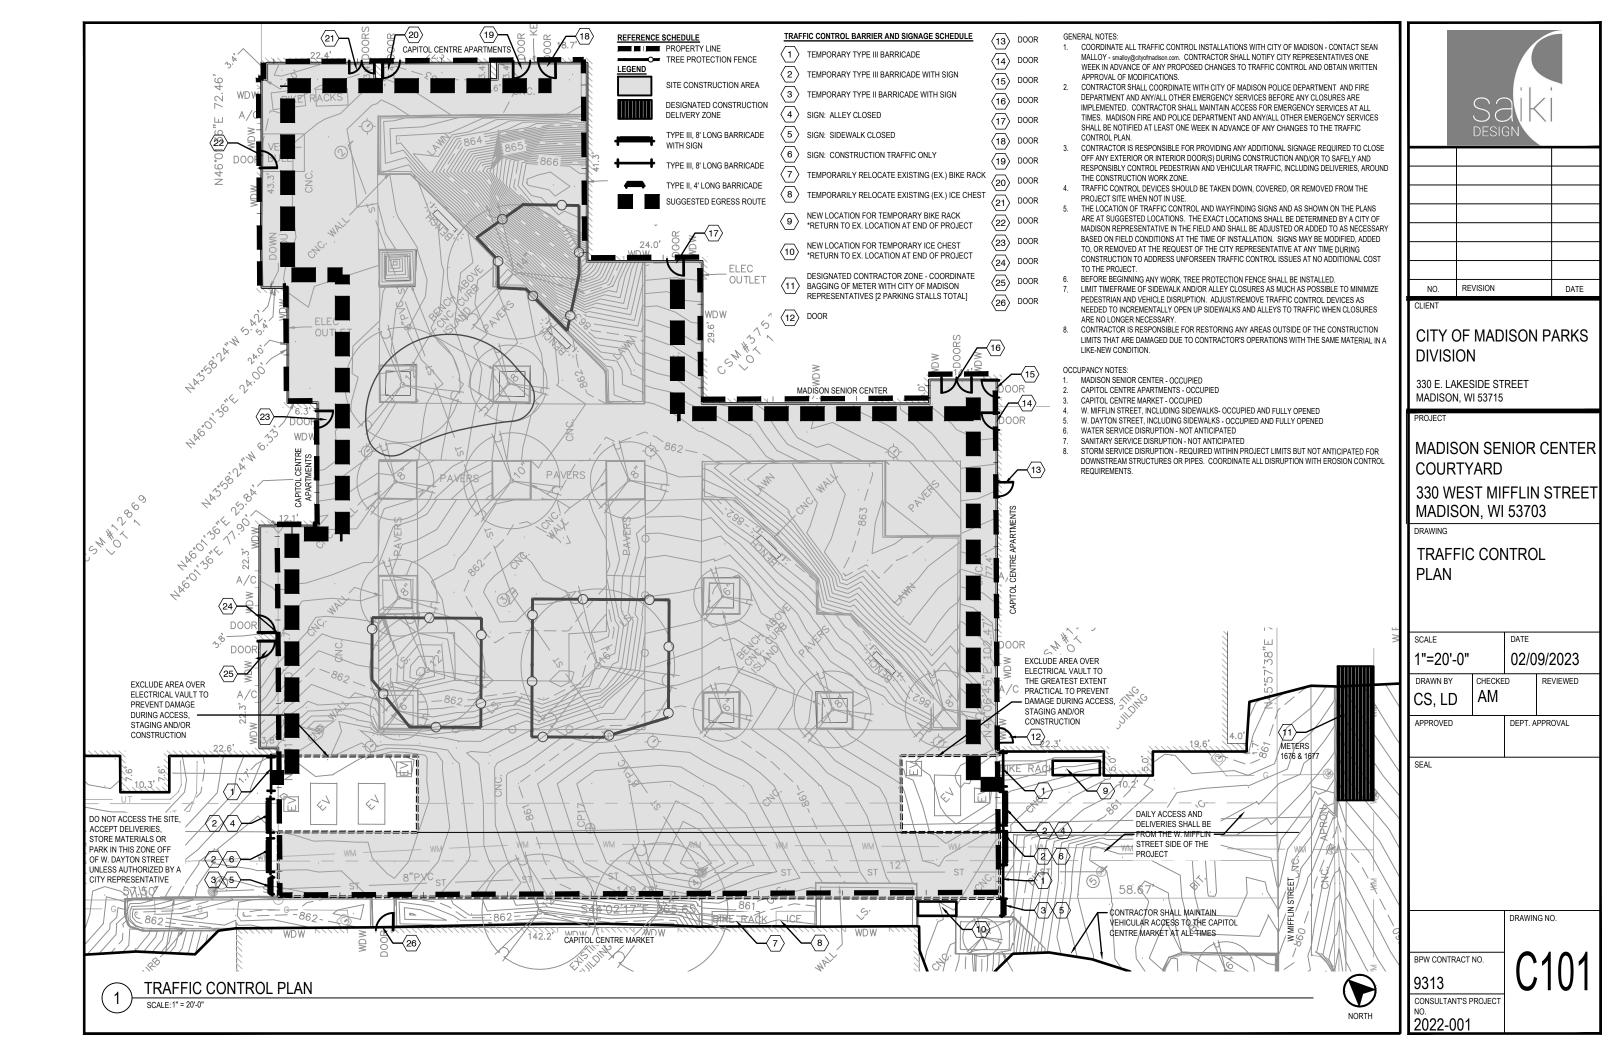
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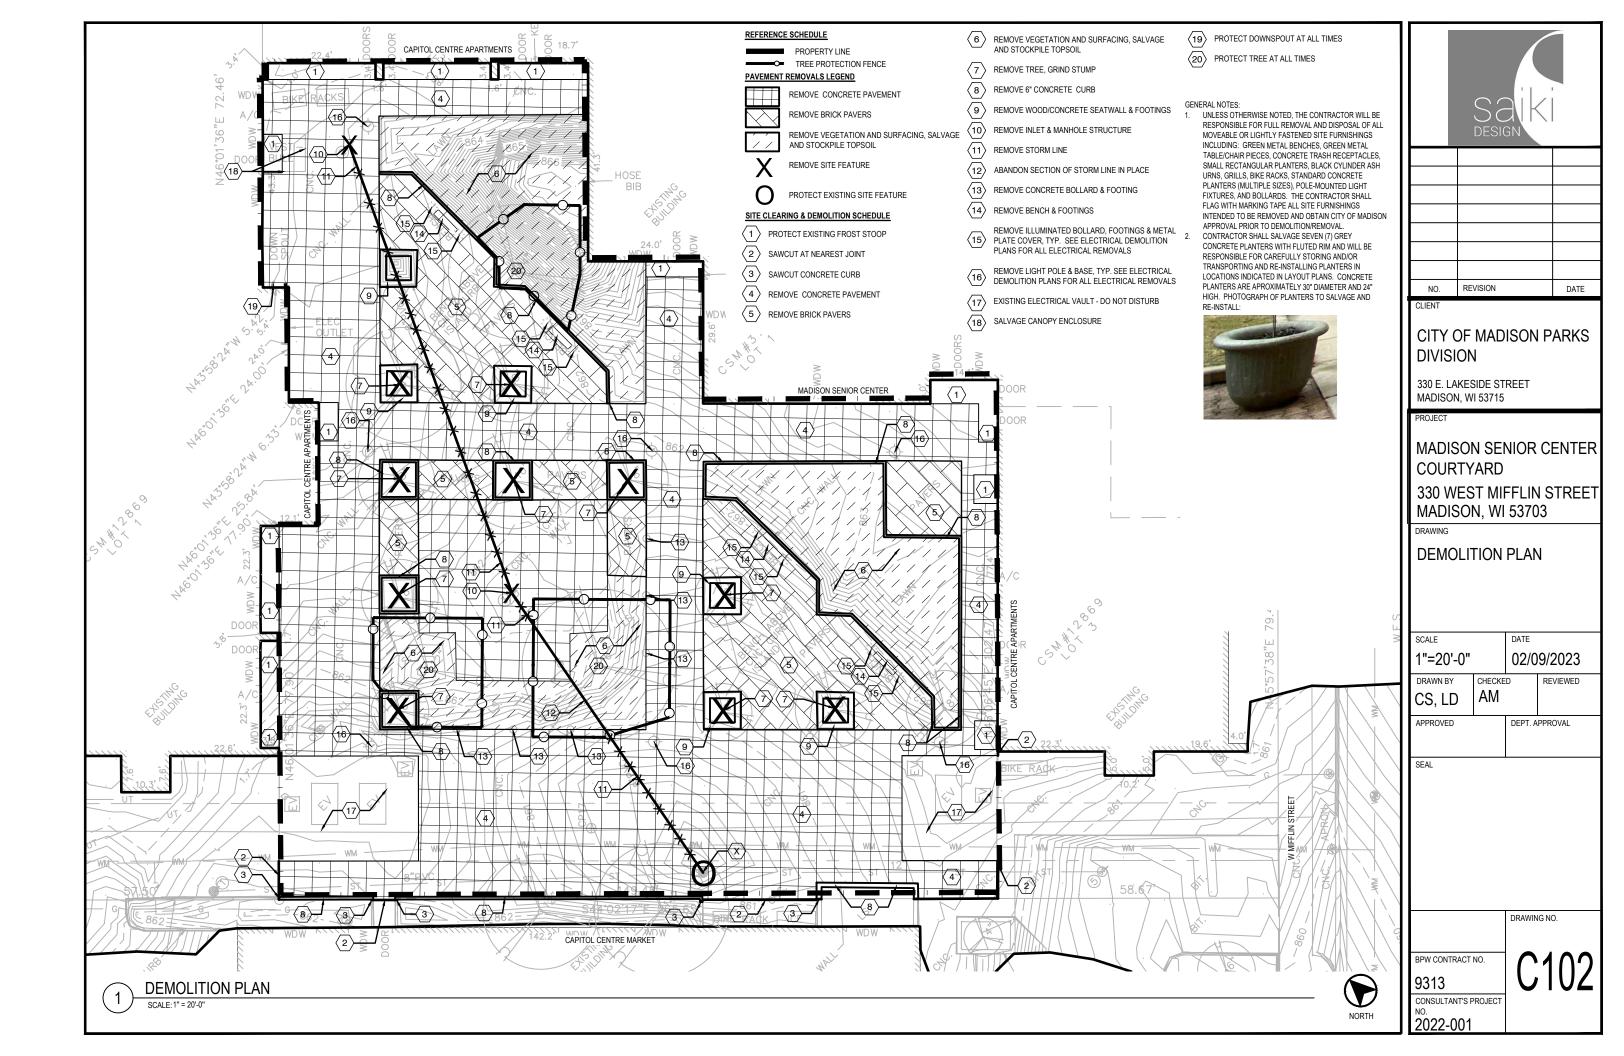


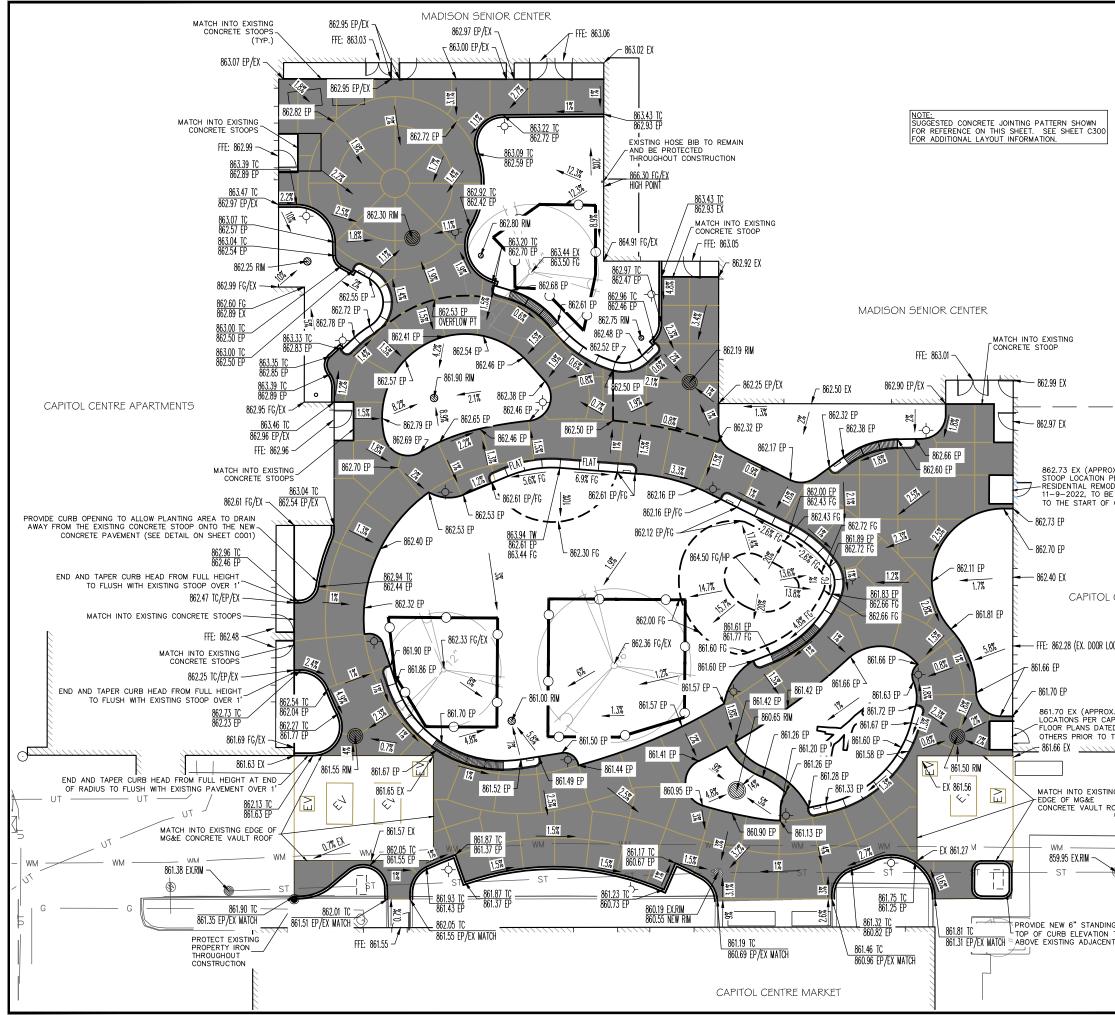
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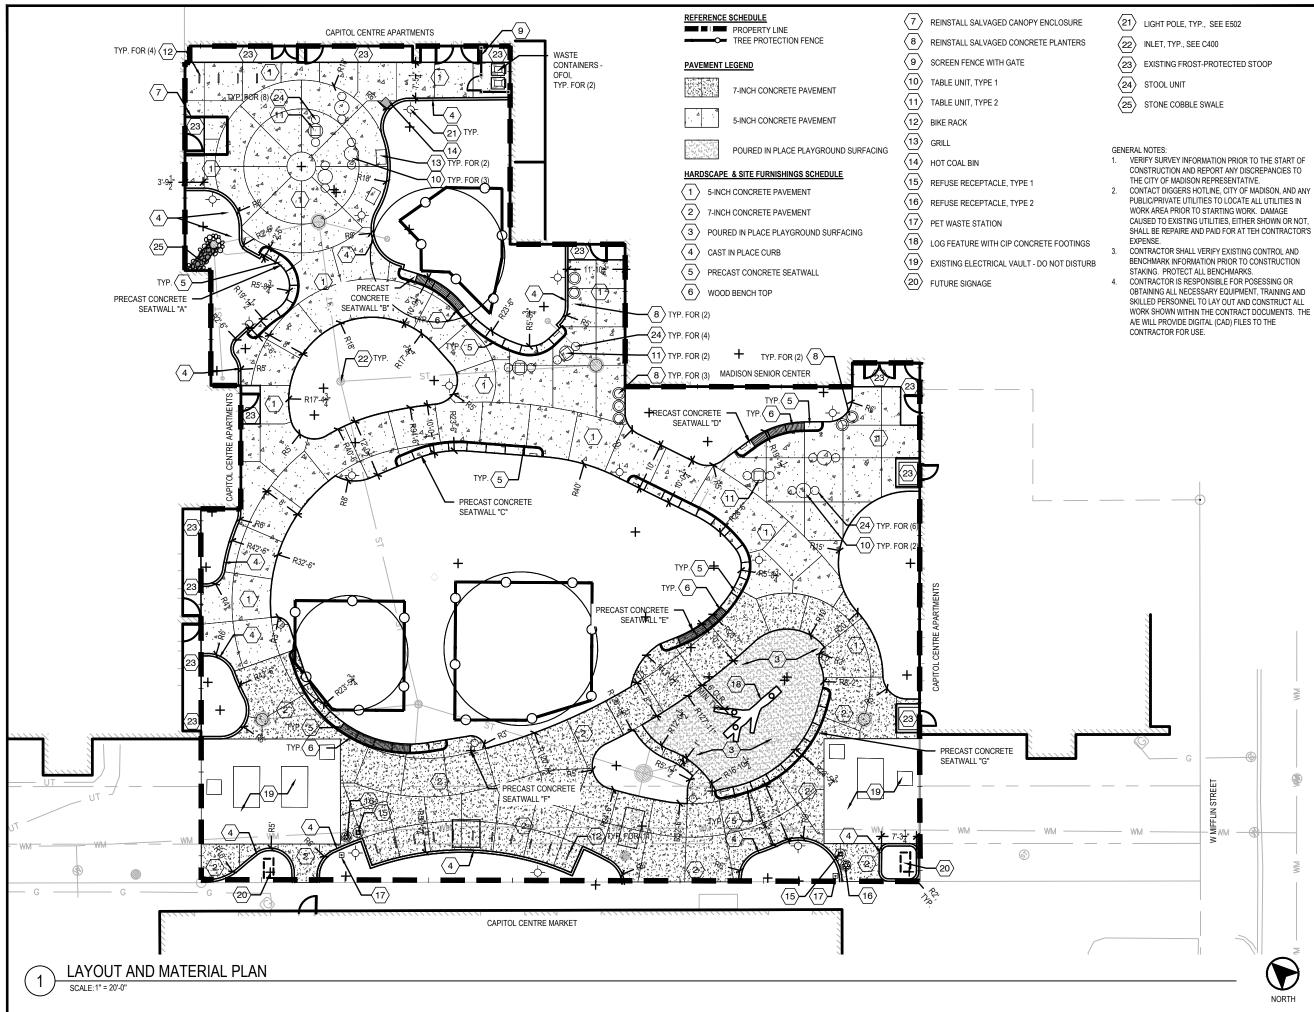
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| IX. NEW DOOR AND CONCRETE FER CAPITOL CENTRE DELING FLOOR PLAN DATED E INSTALLED BY OTHERS PRIOR | COUR 330 W | SON SEI TYARD EST MII SON, WI | FFLIN S | |
| CONSTRUCTION) | DRAWING | ING PL/ | | |
| CENTRE APARTMENTS | | | | |
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| U K. NEW DOOR AND CONCRETE STOOP PITOL CENTRE RESIDENTIAL REMODELING DI 11-9-2022, TO BE INSTALLED BY THE START OF CONSTRUCTION) | APPROVED | | DEPT. APPF | KOVAL |
| FFE: 860.95 G | SEAL | | | |
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| CITY OF MADISON PARKS DIVISION | | | | | |
| | KESIDE STREET N, WI 53715 | | | | |

ROJECT

MADISON SENIOR CENTER COURTYARD

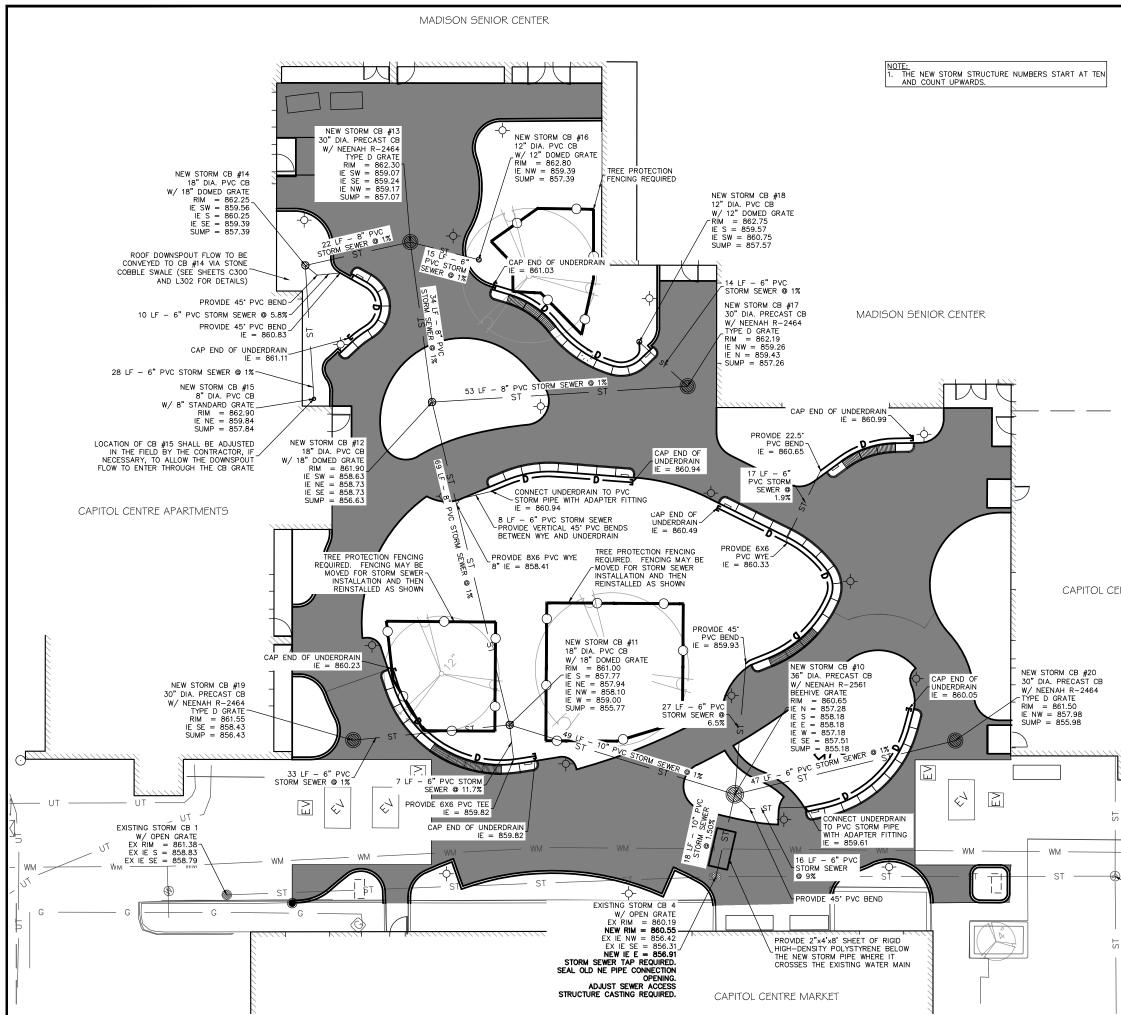
330 WEST MIFFLIN STREET **MADISON, WI 53703**

DRAWING

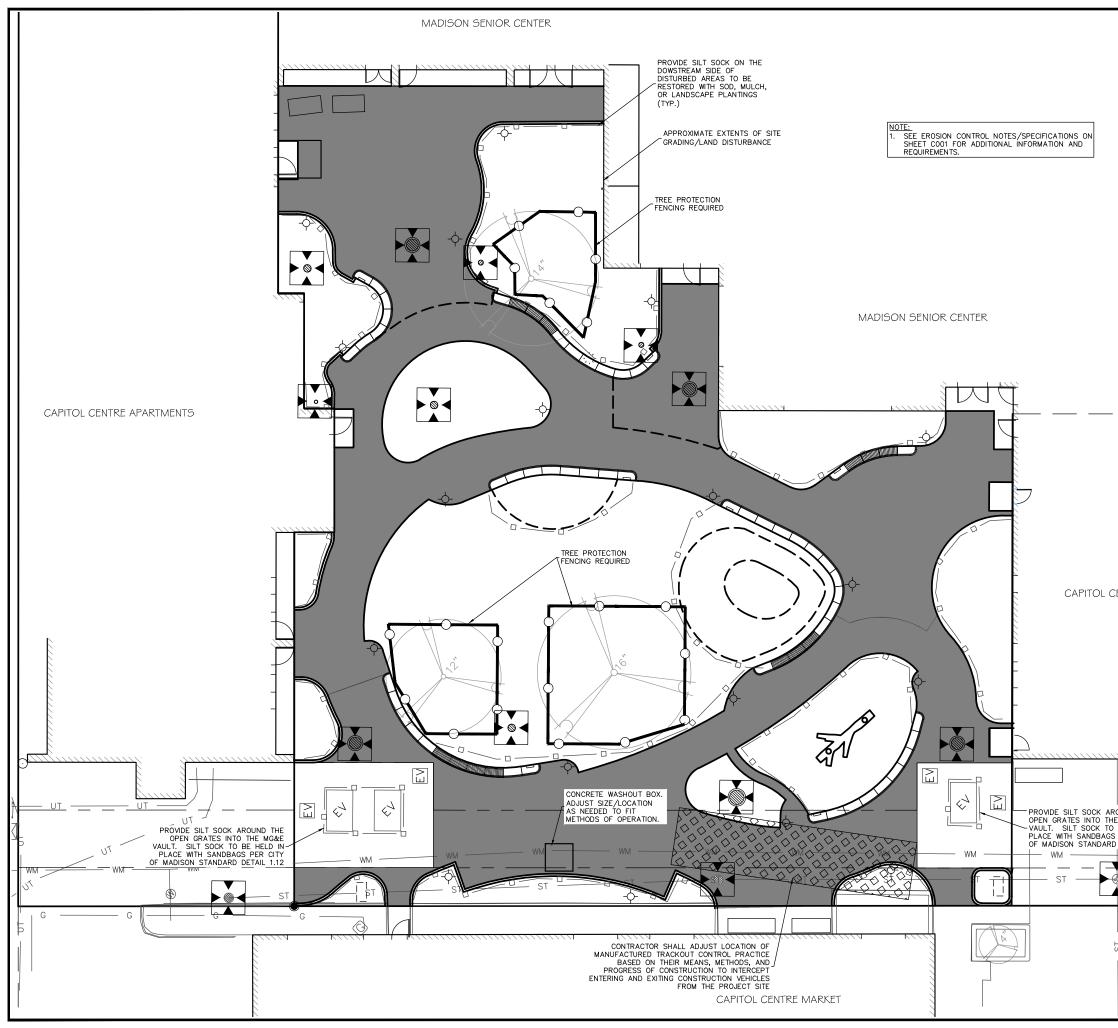
LAYOUT AND MATERIALS PLAN

| SCALE | | DATE | | |
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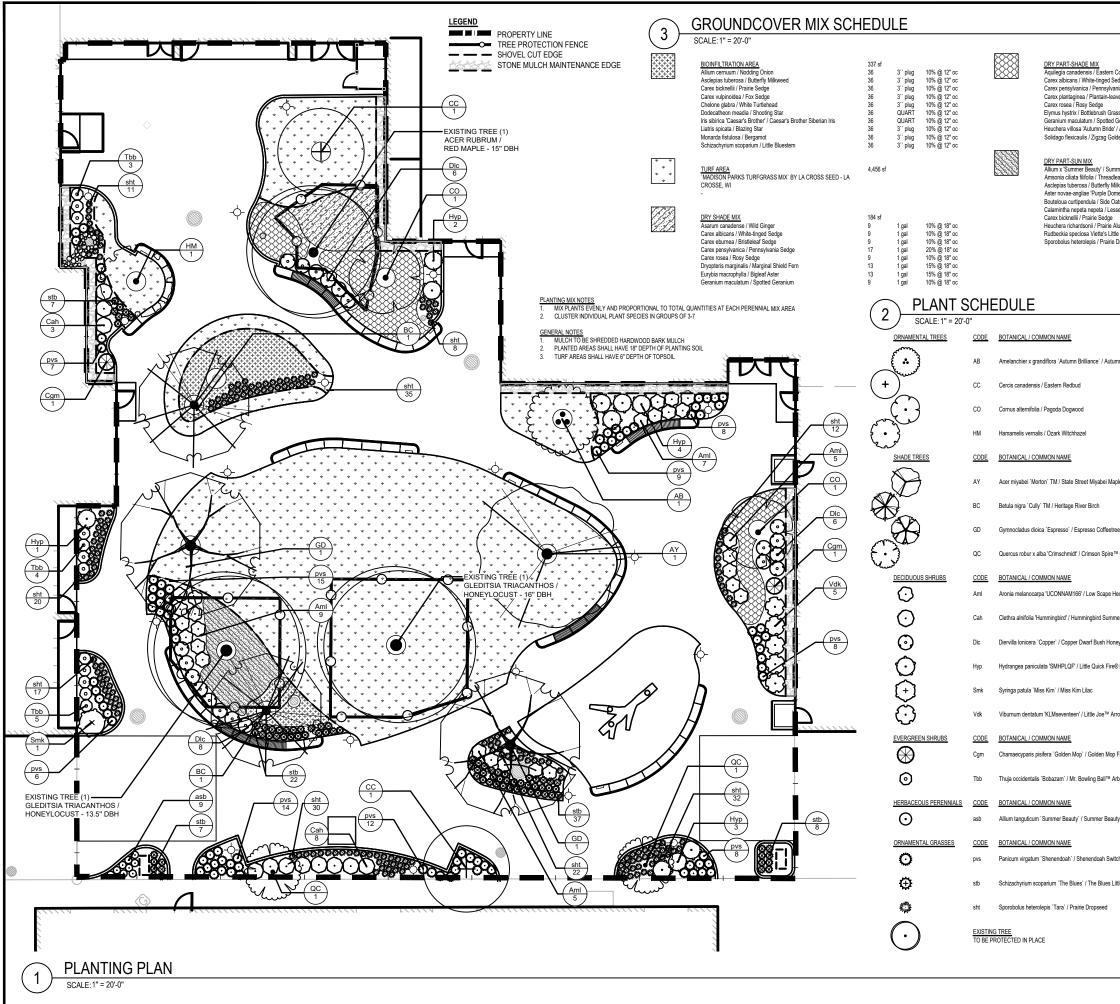
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| je j | 9313 | NT'S PROJECT | 04 | -00 |
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| | | | Surveyin Engineer Internation Madison, | ing, Inc. Il Lane, Suit WI 53704 -250-9263 250-9266 e@BSE-INC.r | e 101 net |
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| cound The BE MG&E BE HELD IN 5 PER CITY 0 DETAIL 1.12 + WM WM | WA | | | | |
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|---------------------------------------|--------|-------|--------------|
| - · · · · | 664 sf | | |
| rn Columbine | 31 | 1 gal | 10% @ 18" oc |
| 1 Sedge | 47 | 1 gal | 15% @ 18" oc |
| Ivania Sedge | 31 | 1 gal | 10% @ 18" oc |
| leaved Sedge | 47 | 1 gal | 15% @ 18" oc |
| 5 | 31 | 1 gal | 10% @ 18" oc |
| Grass | 31 | 1 gal | 10% @ 18" oc |
| ed Geranium | 31 | 1 gal | 10% @ 18" oc |
| de' / Autumn Bride Hairy Alumroot | 31 | 1 gal | 10% @ 18" oc |
| Goldenrod | 31 | 1 gal | 10% @ 18" oc |
| | | | |
| | | | |
| | 431 sf | | |
| ummer Beauty Ornamental Onion | 20 | 1 gal | 10% @ 18" oc |
| adleaf Bluestar | 20 | 1 gal | 10% @ 18" oc |
| Milkweed | 20 | 1 gal | 10% @ 18" oc |
| Dome' / Purple Dome New England Aster | 20 | 1 gal | 10% @ 18" oc |
| e Oats Grama | 20 | 1 gal | 10% @ 18" oc |
| esser Calamint | 10 | 1 gal | 5% @ 18" oc |
| 10 | 20 | 1 gal | 10% @ 18" oc |
| e Alum Root | 20 | 1 gal | 10% @ 18" oc |
| | | | |
| Little Suzy / Black-eyed Susan | 30 | 1 gal | 15% @ 18" oc |
| rie Dropseed | 20 | 1 gal | 10% @ 18" oc |
| | | | |

| | CONT. | SIZE | <u>QTY</u> |
|------------------------------|-------|---------------------------|------------|
| tumn Brilliance Serviceberry | B & B | UPRIGHT MULTI-STEM | 1 |
| | B & B | 2"Cal | 2 |
| | B & B | 2" Cal, Specimen Quality | 2 |
| | B & B | 2`` Cal, Specimen Quality | 1 |
| | CONT. | SIZE | QTY |
| Naple | B & B | 2"Cal | 1 |
| | B & B | 2"CAL, 6" HT (MIN.) | 2 |
| etree | B & B | 2"Cal | 2 |
| e™Oak | B & B | 2"Cal | 2 |
| | CONT | SIZE | QTY |
| Hedger® Black Chokeberry | 5 gal | 24" HT (MIN.) | 26 |
| nmersweet | 5 gal | 24" HT. (MIN.) | 11 |
| oneysuckle | 2 gal | 18" HT (MIN.) | 20 |
| re® Panicle Hydrangea | 5 gal | 24" HT (MIN.) | 10 |
| | 3 gal | 24" HT (MIN.) | 1 |
| Arrowwood Viburnum | 5 gal | 30" HT (MIN.) | 5 |
| | CONT | SIZE | QTY |
| op False Cypress | 3 gal | 18" HT. (MIN.) | 2 |
| Arborvitae | 3 gal | 18" HT (MIN.) | 12 |
| | CONT | SIZE | QTY |
| auty Allium | 1 gal | | 9 |
| | CONT | SIZE | QTY |
| witch Grass | 1 gal | | 87 |
| Little Bluestem | 1 gal | | 81 |
| | 1 gal | | 188 |
| | | | 3 |
| | | | - |



CITY OF MADISON PARKS DIVISION

330 E. LAKESIDE STREET MADISON, WI 53715

PROJECT

MADISON SENIOR CENTER COURTYARD

330 WEST MIFFLIN STREET **MADISON, WI 53703**

DRAWING

PI ANTING PLAN

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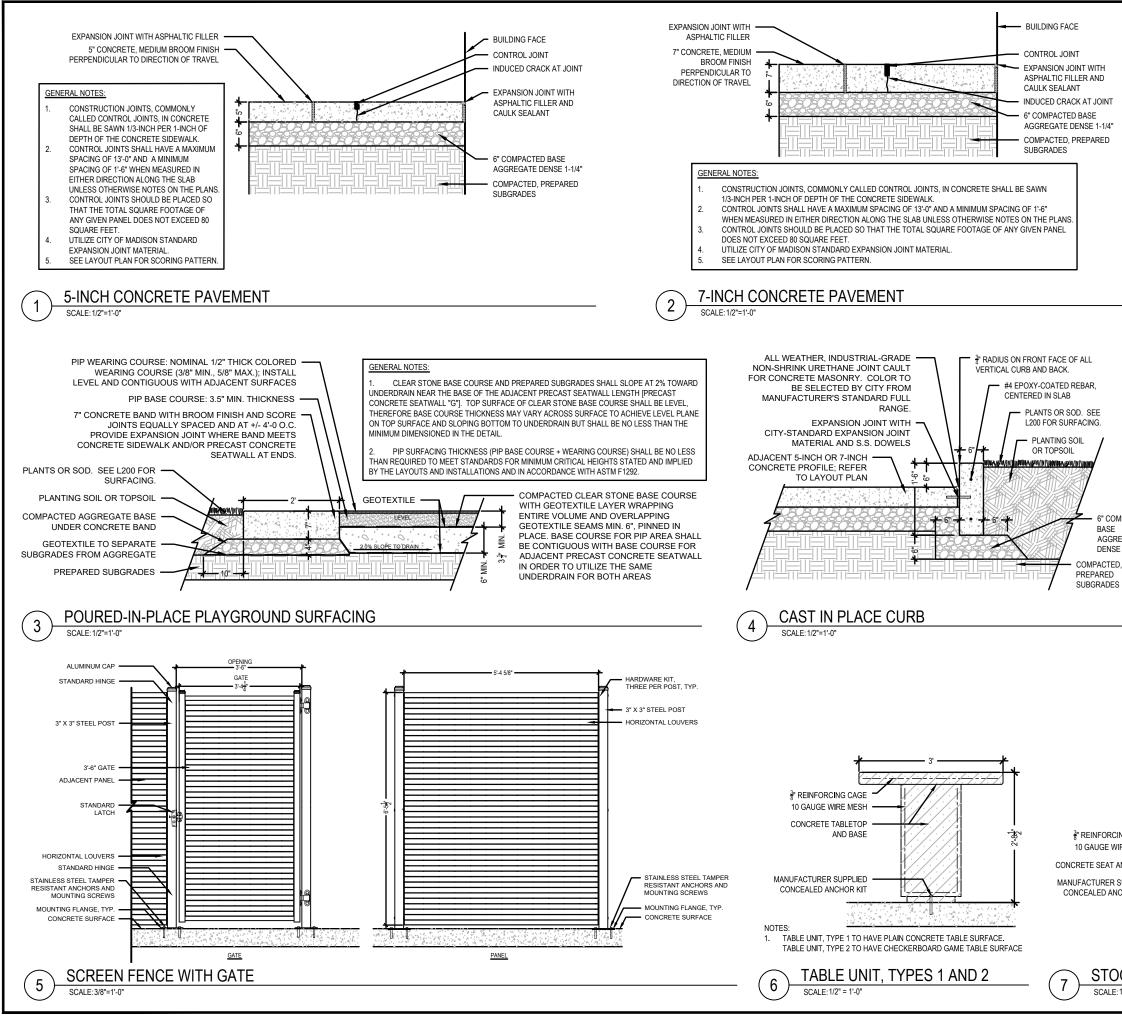
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BPW CONTRACT NO.

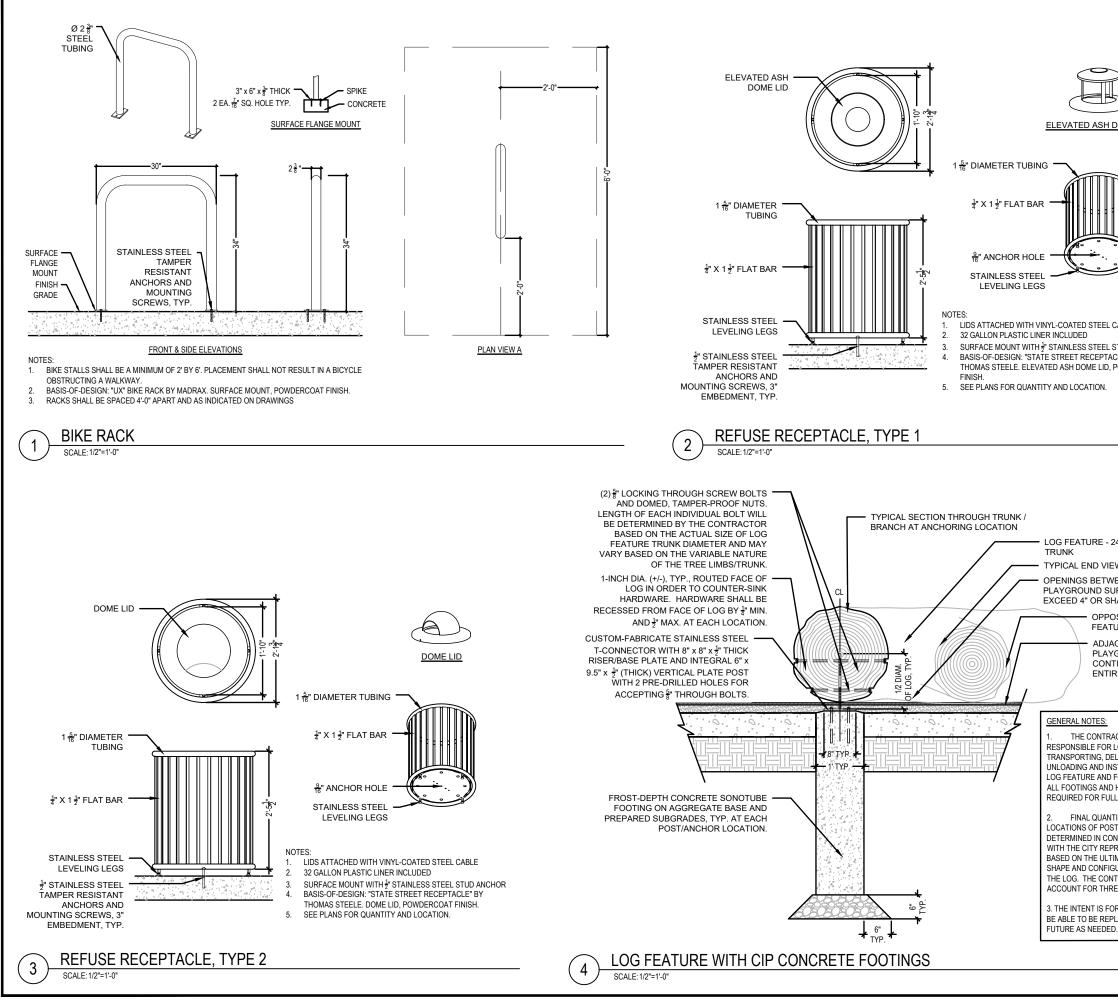
9313 CONSULTANT'S PROJECT NO

2022-001

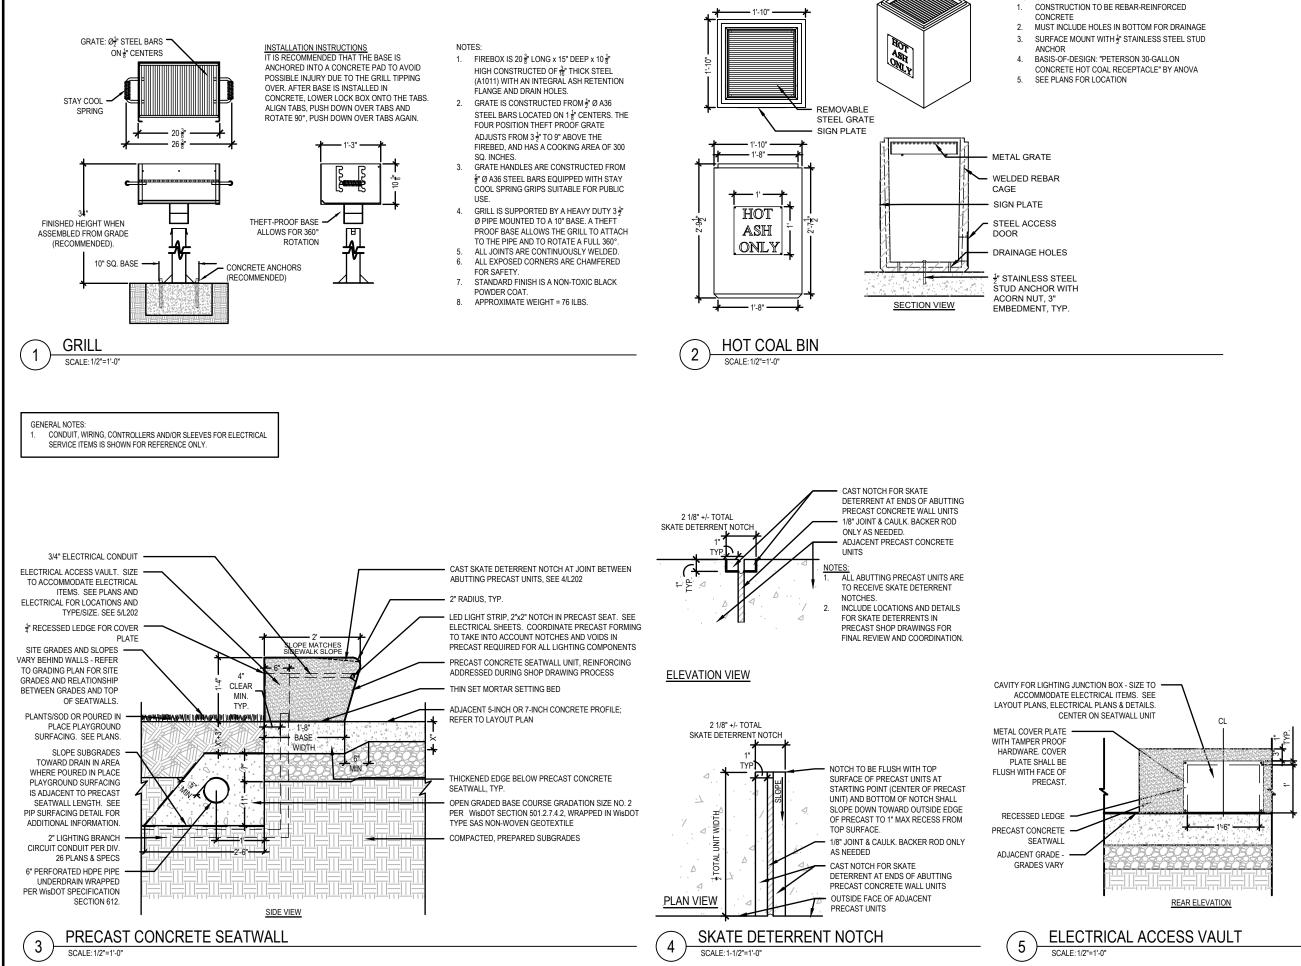
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| | NO. | REVISION | | DATE |
| | | of Mad On | ISON P | PARKS |
| GENERAL NOTES: 1. SPACE STAINLESS STEEL | | AKESIDE ST N, WI 53715 | | |
| DOWELS 36-INCHES O.C., OR AS NEEDED. 2. PROVIDE A RUBBED FINISH ON ALL EXPOSED SURFACES OF CONCRETE CURB. | COUR 330 W | TYARD | FFLIN S | ENTER STREET |
| COMPACTED SE GGREGATE INSE 1-1/4" ITED, ED DES | DRAWING | DETAILS | | |
| | SCALE | | DATE 02/09/ | 2023 |
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| OOL UNIT | CONSULTANNO. | NT'S PROJECT | | |

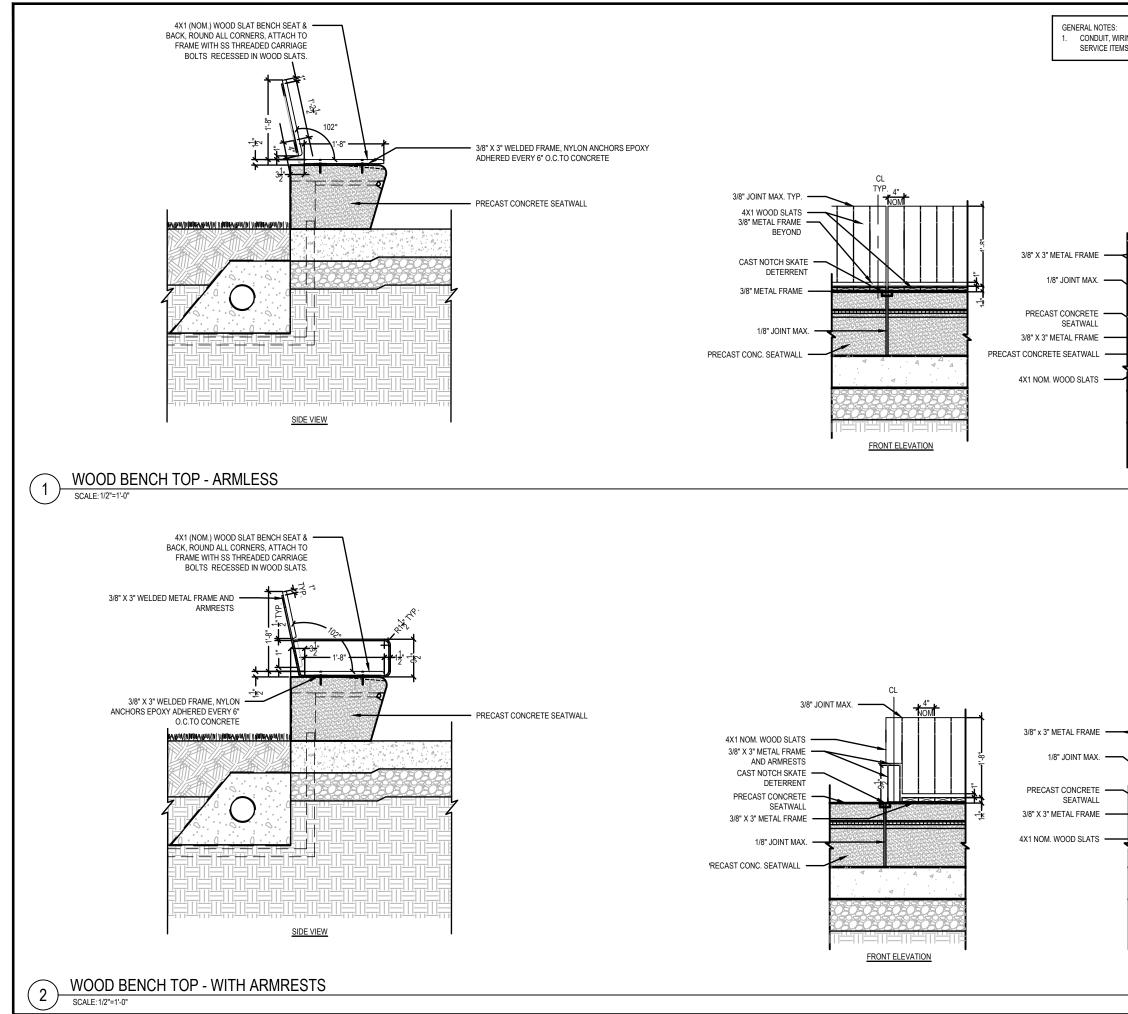


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| L CABLE L STUD ANCHOR FACLE" BY 2. POWDERCOAT | CITY O DIVISI | OF MAD ION AKESIDE ST N, WI 53715 | REET | PARKS |
| | PROJECT | | | |
| | COUR 330 W MADIS | TYARD | FFLIN | |
| | DRAWING | | 3 | |
| - 24-30" DIAM. | | | - | |
| IEW OF LIMB | | | | |
| WEEN LOG FEATURE AND SURFACING SHALL NOT SHALL BE GREATER THAN 9" | SCALE | | DATE | |
| POSITE END OF LOG | JUALE | | | /2023 |
| | DRAWN BY | | | REVIEWED |
| AYGROUND SURFACING - NTINUOUS AROUND TIRE LOG FEATURE. | CS, LE |) AM | | |
| | APPROVED | 1 | DEPT. APF | PROVAL |
| RACTOR WILL BE IR LOADING, DELIVERING, INSTALLING THE ID FOR PROVIDING ND HARDWARE ULL INSTALLATION. INTITIES AND DSTS SHALL BE CONSULTATION EPRESENTATIVE LTIMATE SIZE, ICULUATION CE | SEAL | | 1 | |
| FIGURATION OF INTRACTOR SHALL IREE (3) FOOTINGS. | | | DRAWING | NO. |
| FOR THE LOG TO EPLACED IN THE ED. | BPW CONTR 9313 CONSULTAT | RACT NO. | | 201 |
| | NO. 2022-0 | | | |

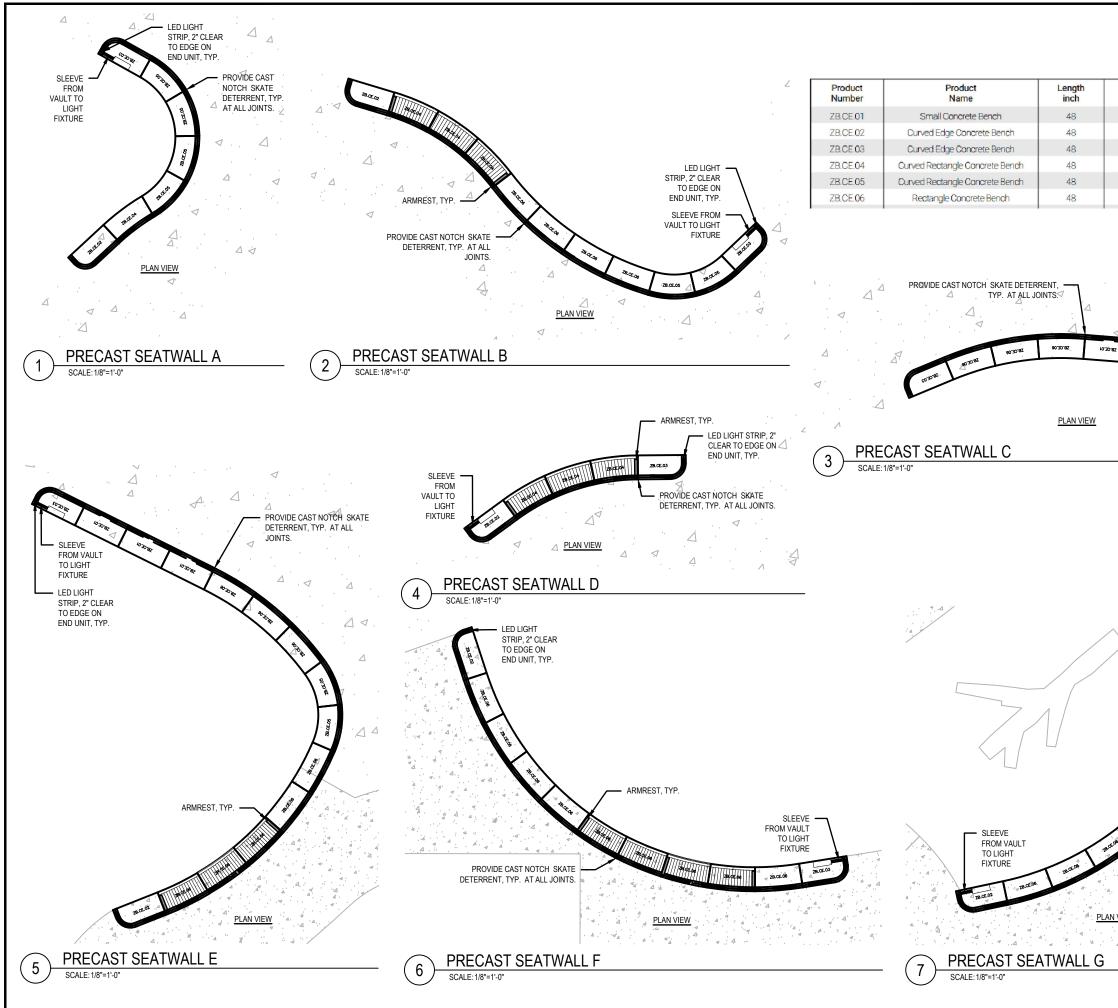


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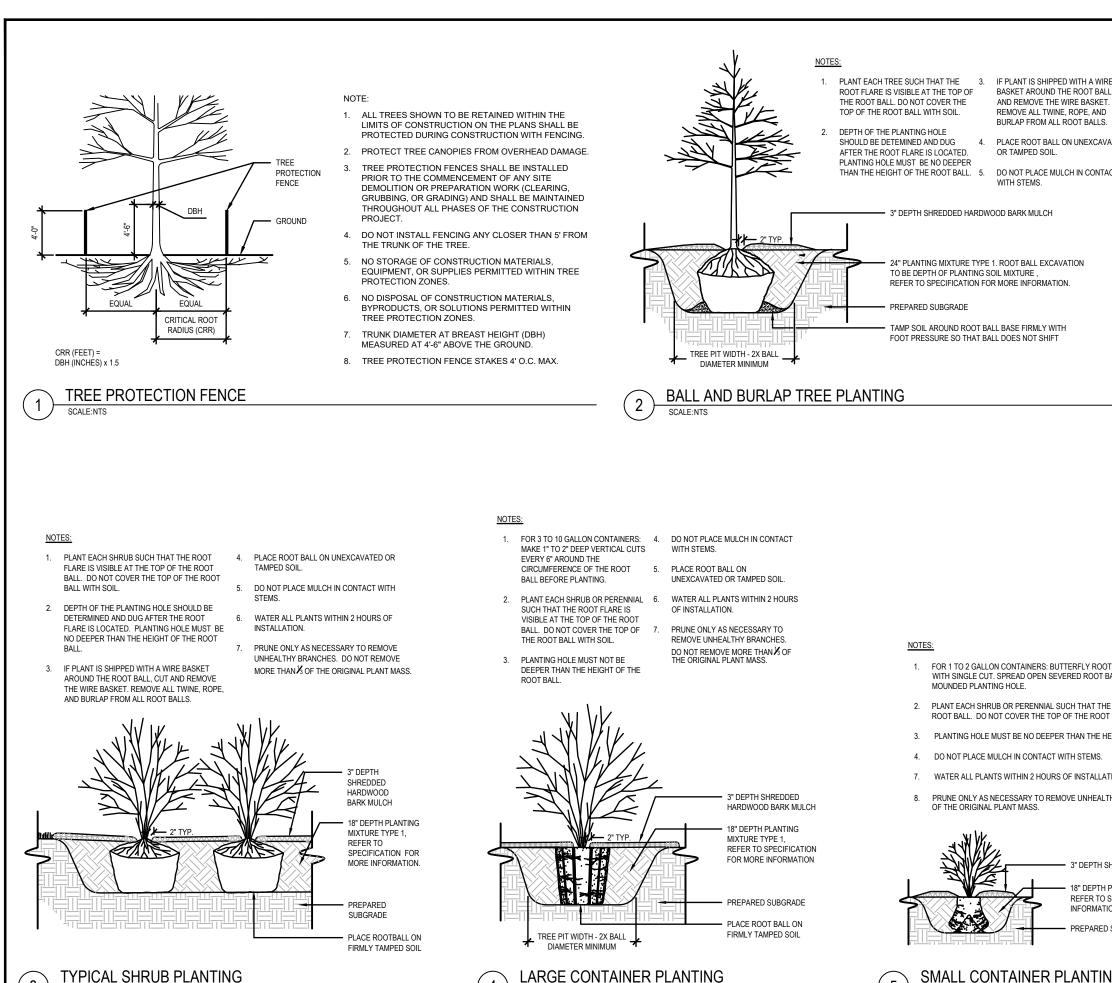
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| CITY (DIVISI 330 E. LA | KESIDE ST | | ARKS | |
| MADISON, WI 53715 PROJECT MADISON SENIOR CENTER COURTYARD 330 WEST MIFFLIN STREET MADISON, WI 53703 DRAWING SITE DETAILS | | | | |
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| drawn by CS, LD | CHECKE AM | | VIEWED | |
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| IRING, CONTROLLERS AND/OR SLEEVES FOR ELECTRICAL | NO. CLIENT | REVISION | | DATE |
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| | PROJECT MADIS COUR 330 W | SON SE | nior (Fflin | CENTER STREET |
| | SITE D | DETAILS | 5 | |
| | SCALE | | DATE | /2023 |
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| REAR ELEVATION | BPW CONTR 9313 CONSULTAN NO. 2022-0 | T'S PROJECT | DRAWING | ^{NO.} |



| Width inch 24 24 24 24 24 24 24 | Height inch 16 16 16 16 16 | Weight Ibs/p 1,500 1,377 1,377 1,416 1,295 | Saiki |
|---|--|--|---|
| 24 | 16 | 1,425 | |
| LED L | CEVE FROM VAULT LIGHT FIXTU JIGHT STRIP, 2" CLE GE ON END UNIT, T | | NO. REVISION DATE CLIENT CITY OF MADISON PARKS DIVISION DIVISION 330 E. LAKESIDE STREET MADISON, WI 53715 PROJECT PROJECT MADISON SENIOR CENTER COURTYARD 330 WEST MIFFLIN STREET MADISON, WI 53703 DRAWING PRECAST SEATWALL LAYOUTS |
| | | | SCALE DATE 02/09/2023 |
| STRIP, 2" | | | DRAWN BY CHECKED REVIEWED |
| TO ED END UNI | DGE ON IT, TYP. | | CS, LD AM |
| | a co | | APPROVED DEPT. APPROVAL |
| n view | | CAST NOTCH ETERRENT, TYP. DINTS. | SEAL BPW CONTRACT NO. 9313 CONSULTANT'S PROJECT NO. 2022-001 |



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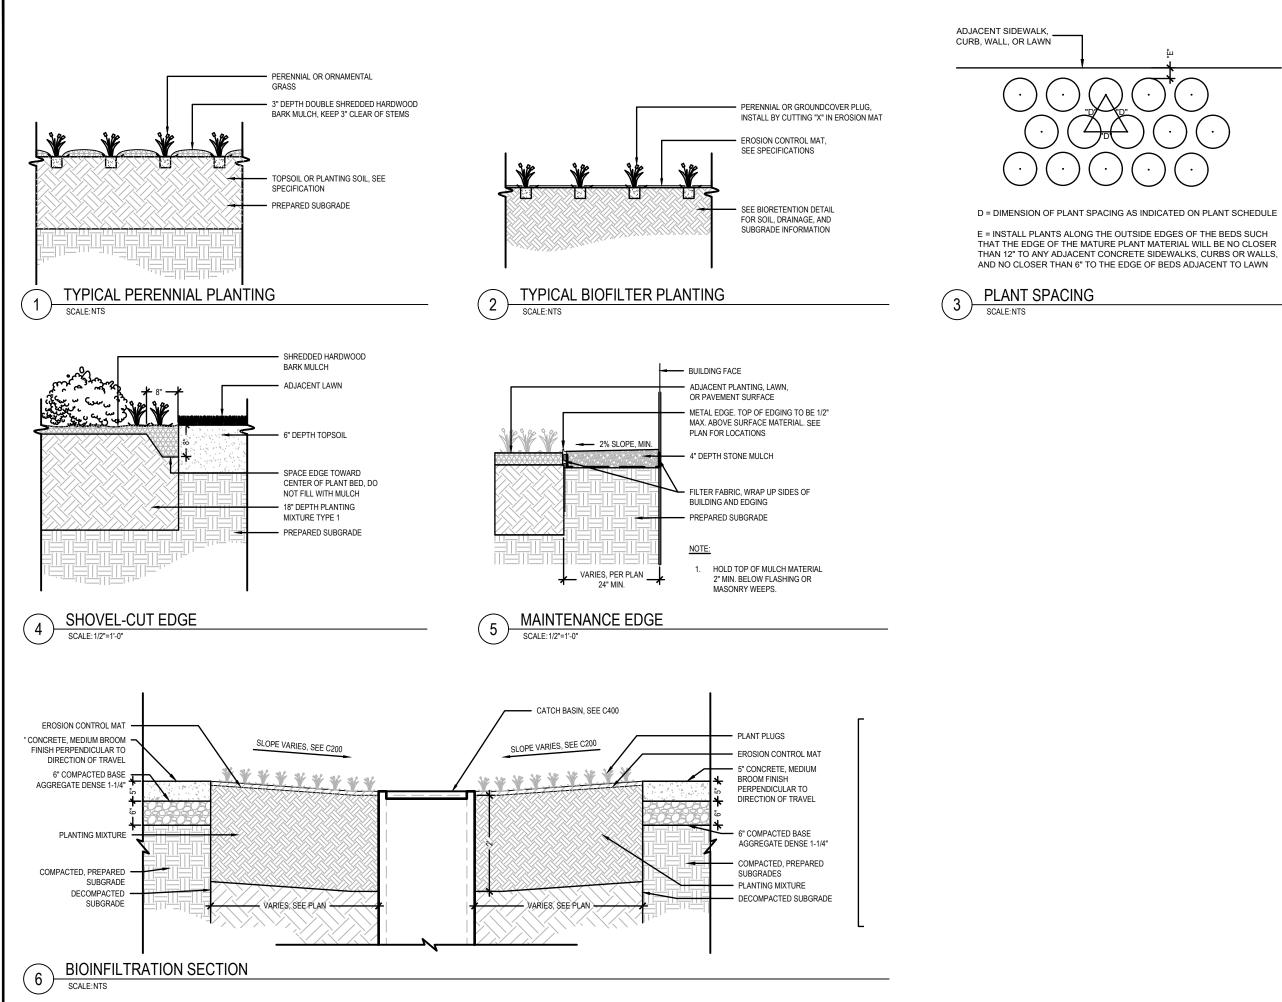
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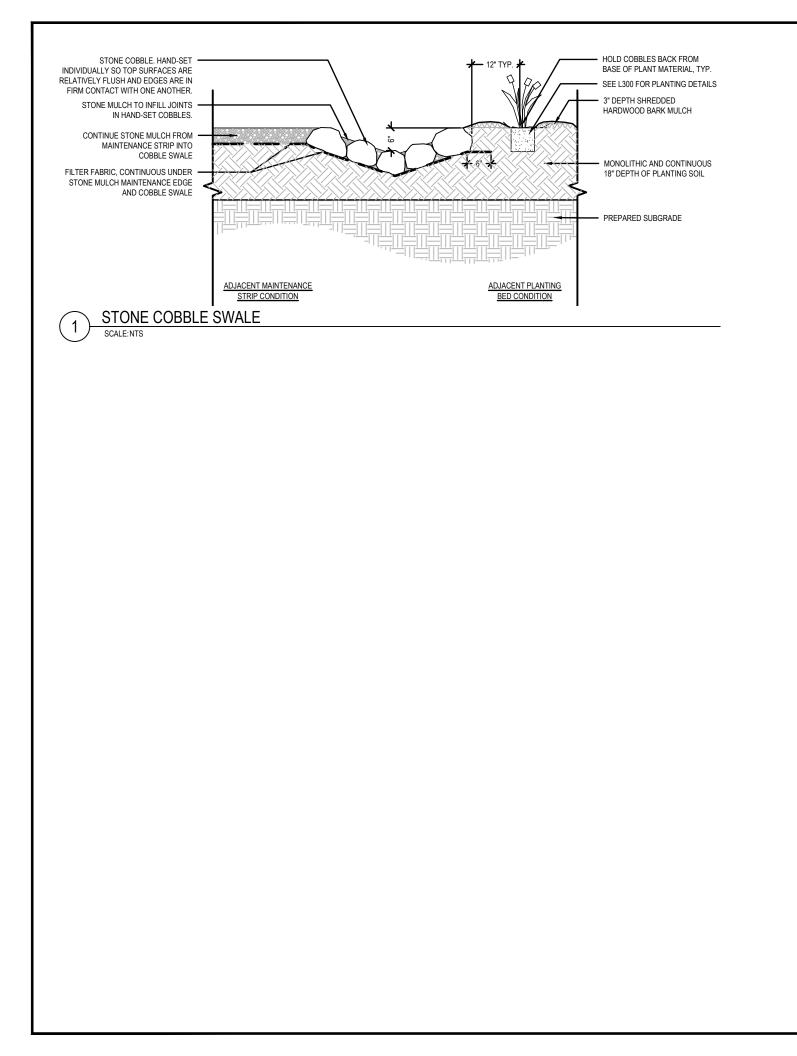
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SCALE:NTS

| WATER ALL PLANTS WITHIN 2 HOURS CUT OF INSTALLATION. PRUNE ONLY AS NECESSARY TO REMOVE UNHEALTHY BRANCHES. DO NOT REMOVE MORE THAN % OF THE ORIGINAL PLANT MASS. | | Sc | | - |
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| | | N, WI 53715 | | |
| | COUR 330 W | TYARD | FFLIN S | ENTER STREET |
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| | LAND | SCAPE | DETAIL | .S |
| | SCALE | | DATE | |
| | | | 02/09/ | 2023 |
| BALL. SEVER LOWER $rac{1}{3}$ TO $rac{1}{2}$ OF ROOT BALL ALL AND PLACE AGAINST BOTTOM OF | DRAWN BY | CHECKE | ED RE | EVIEWED |
| STEM FLARE IS VISIBLE AT THE TOP OF THE | CS, LD |) AM | | |
| BALL WITH SOIL. | APPROVED | | DEPT. APPF | ROVAL |
| IGHT OF THE ROOT BALL. | | | | |
| ION. | SEAL | | | |
| HY BRANCHES. DO NOT REMOVE MORE THAN $ ot\!\!\!/ S$ | | | | |
| | | | | |
| | | | | |
| IREDDED HARDWOOD BARK MULCH | | | | |
| PLANTING SOIL MIXTURE TYPE 1, PECIFICATION FOR MORE | | | | 0 |
| SUBGRADE | | | DRAWING N | IU. |
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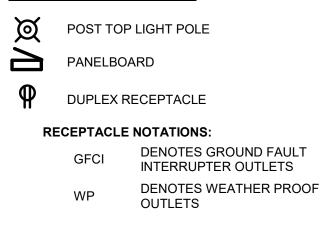


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| M C 33 M | MADISON, WI 53715 PROJECT MADISON SENIOR CENTER COURTYARD 330 WEST MIFFLIN STREET MADISON, WI 53703 DRAWING LANDSCAPE DETAILS | | | | | |
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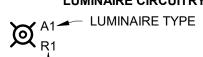


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| PROJECT | | | | | |
| MADISON SENIOR CENTER COURTYARD 330 WEST MIFFLIN STREET MADISON, WI 53703 DRAWING LANDSCAPE DETAILS | | | | | |
| LANDS | SCAPE | DETA | ILS | | |
| LANDS | SCAPE | DATE | | | |
| SCALE | | DATE 02/0 | 9/2023 | | |
| SCALE DRAWN BY | СНЕСК | DATE 02/0 | | | |
| SCALE | СНЕСК | DATE 02/0 ED | 9/2023 | | |
| SCALE DRAWN BY CS, LD | СНЕСК | DATE 02/0 ED | 9/2023 REVIEWED | | |
| SCALE DRAWN BY CS, LD APPROVED | СНЕСК | DATE 02/0 ED | 9/2023 REVIEWED | | |
| SCALE DRAWN BY CS, LD APPROVED | СНЕСК | DATE 02/0 ED DEPT. AI | 9/2023 REVIEWED PPROVAL | | |
| SCALE DRAWN BY CS, LD APPROVED SEAL | CHECK | DATE 02/0 ED DEPT. AI | 9/2023 REVIEWED PPROVAL | | |
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SITE SYMBOLS



LUMINAIRE CIRCUITRY & CONTROL KEY:



(R#) INDICATES RELAY # IN LIGHTING RELAY SCHEDULE

GENERAL SYMBOLS

#/E-### DETAIL NUMBER / SHEET NUMBER

KEYED NOTE, USED TO DESCRIBE ADDITIONAL (9.**###**) INFORMATION OF WORK REQUIRED. SPECIFIC TO THE SHEET AND/OR DETAIL IT IS SHOWN WITH.

ELECTRICAL ABBREVIATIONS

- 3R NEMA 3R RATING
- А AMPERES
- A/E ARCHITECT / ENGINEER
- AFF ABOVE FINISHED FLOOR
- AFG ABOVE FINISHED GRADE
- С CONDUIT
- СВ **CIRCUIT BREAKER**
- CKT CIRCUIT
- DWG DRAWING
- EC ELECTRICAL CONTRACTOR
- GC GENERAL CONTRACTOR
- GFCI **GROUND FAULT CIRCUIT INTERRUPTER**
- GND GROUND
- PH PHASE
- RECPT RECEPTACLE
- TYP TYPICAL
- UG UNDERGROUND
- UNO UNLESS NOTED OTHERWISE
- V VOLTS
- W WATTS
- WL WET LOCATION LISTED
- WP WEATHERPROOF

GENERAL NOTES:

- 1. THE CONTRACTOR SHALL BECOME FAMILIAR WITH THE DETAILS OF WORK. VERIFY DIMENSIONS IN THE FIELD, AND ADVISE THE [ARCHITECT/ENGINEER] **ICONTRACTING OFFICERI OF ANY DISCREPANCY** BEFORE PERFORMING ANY WORK.
- 2. THE COMPLETE INSTALLATION SHALL BE IN ACCORDANCE WITH THE ADAAG (AMERICANS WITH DISABILITIES ACT ACCESSIBILITY GUIDELINES) AND ABA (ARCHITECTURAL BARRIERS ACT).
- 3. CIRCUIT NUMBERS ARE SHOWN FOR CIRCUIT IDENTIFICATION. CIRCUITING SHALL AGREE WITH NUMBERING ON THE PANEL SCHEDULES PROVIDED. BALANCE THE LOAD ON PANELS AS EVENLY AS POSSIBLE BETWEEN EACH PHASE. COMMON NEUTRALS MAY [NOT] BE USED FOR BRANCH CIRCUITS.
- 4. A #12 GREEN INSULATED GROUND CONDUCTOR SHALL BE INSTALLED WITH CIRCUIT CONDUCTORS TO ALL RECEPTACLES.
- 5. CONTRACTOR SHALL BE RESPONSIBLE FOR ALL OPENINGS REQUIRED IN WALLS. ALL OPENINGS SHALL BE REPAIRED TO MATCH EXISTING BY A QUALIFIED CONTRACTOR AT THE EXPENSE OF THIS CONTRACTOR. ALL CONDUITS THROUGH WALLS SHALL BE GROUTED OR SEALED INTO OPENINGS.
- 6. SCCR RATINGS LISTED FOR EQUIPMENT ARE MINIMUM REQUIREMENTS FOR BUS BRACING AND DEVICE RATING. ALL EQUIPMENT SHALL BE FULLY RATED UNLESS SPECIFICALLY NOTED AS SERIES RATED.

DEMOLITION GENERAL NOTES:

- 1. THE INFORMATION SHOWN IS BASED ON EXISTING DRAWINGS AND SITE OBSERVATIONS TO ASSIST CONTRACTOR IN BIDDING. THE ELECTRICAL DRAWINGS INDICATE EXISTING ELECTRICAL ITEMS TO BE REMOVED. THE DRAWINGS ARE INTENDED TO INDICATE THE SCOPE OF WORK REQUIRED AND DO NOT INDICATE EVERY BOX, CONDUIT, OR WIRE THAT MUST BE REMOVED. THE CONTRACTOR SHALL VISIT THE SITE PRIOR TO SUBMITTING A BID AND VERIFY EXISTING CONDITIONS. REFER TO SPECIFICATION SECTION 26 05 02 FOR ADDITIONAL REQUIREMENTS.
- 2. ALL BOXES THAT REMAIN IN PLACE IN EXISTING MASONRY WALLS THAT ARE TO REMAIN SHALL BE PROVIDED WITH A BLANK COVERPLATE. REFER TO SPECIFICATIONS FOR ADDITIONAL REQUIREMENTS ASSOCIATED WITH TYPE AND ATTACHMENT.
- 3. THIS CONTRACTOR SHALL COORDINATE ALL WORK, INCLUDING PHASING WITH OTHER CONTRACTORS AT THE JOB SITE BEFORE REMOVING EXISTING ELECTRICAL AND INSTALLING NEW ITEMS.
- 4. PROVIDE REVISED TYPED CIRCUIT DIRECTORY IN PANELBOARDS THAT HAVE CIRCUITS REMOVED OR ADDED CIRCUITS.
- 5. REMOVE EXPOSED ABANDONED CONDUIT. INCLUDING ABANDONED CONDUIT ABOVE ACCESSIBLE CEILING FINISHES. CUT RACEWAY FLUSH WITH WALLS AND FLOORS, PATCH SURFACES TO MATCH EXISTING. REMOVE ALL ASSOCIATED CLAMPS, HANGERS, SUPPORTS, ETC. ASSOCIATED WITH RACEWAY REMOVAL.
- 6. DISCONNECT AND REMOVE ABANDONED LUMINAIRES. INCLUDING BRACKETS, STEMS, HANGERS, AND OTHER ACCESSORIES.
- 7. DISCONNECT AND REMOVED ELECTRICAL DEVICES AND EQUIPMENT SERVING UTILIZATION EQUIPMENT THAT HAS BEEN REMOVED.

| Mead & Hunt, Inc. 2440 Deming Way Middleton, WI 53562 phone: 608-273-6380 meadhunt.com | | | | | |
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DIVISION

330 F. LAKESIDE STREET MADISON, WI 53715

PROJECT

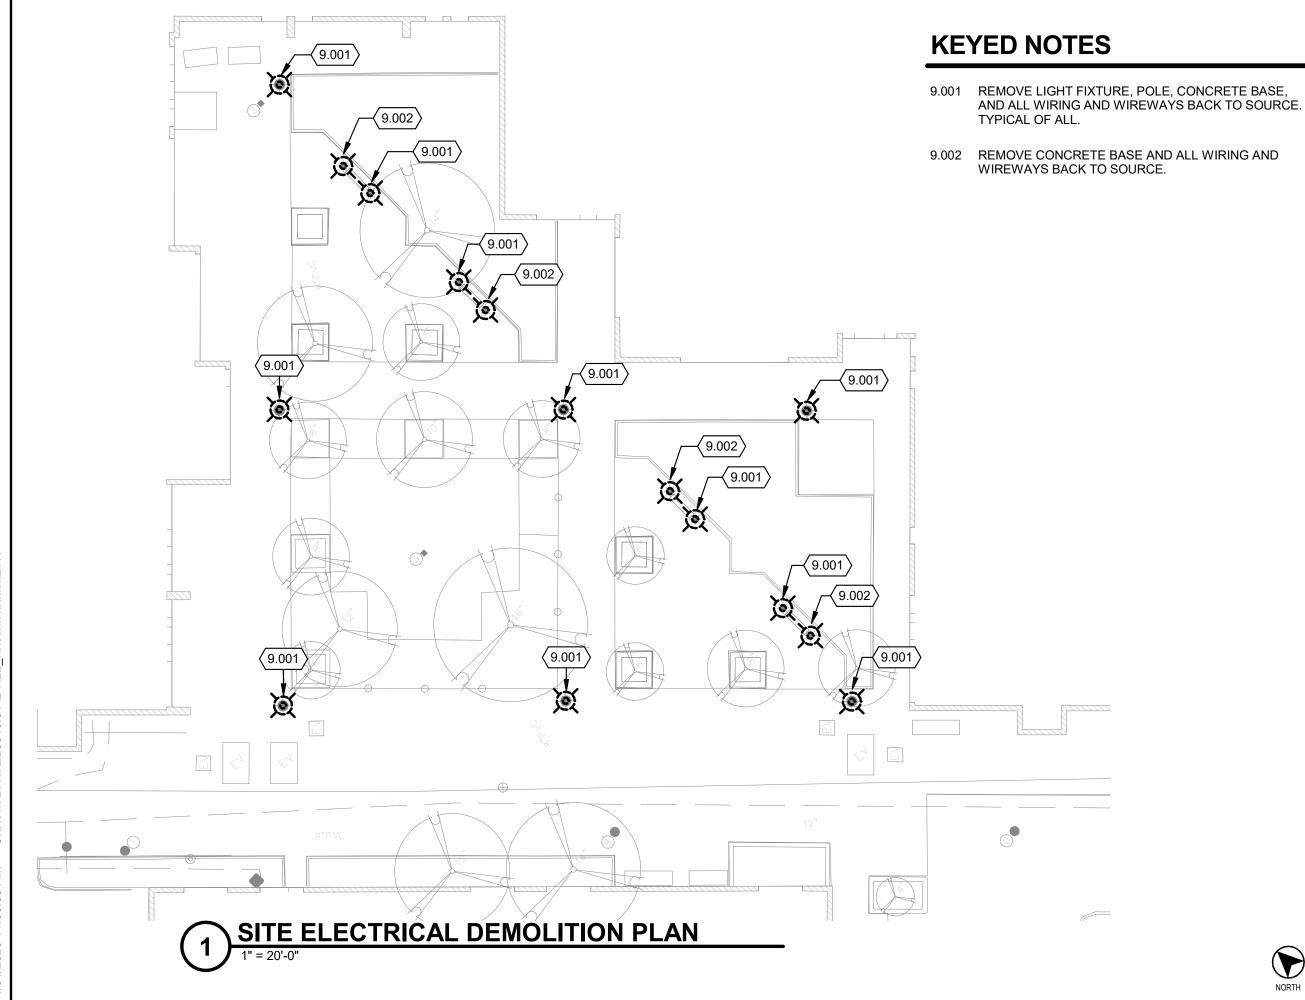
MADISON SENIOR CENTER COURTYARD

330 WEST MIFFLIN STREET MADISON, WI 53703

DRAWING

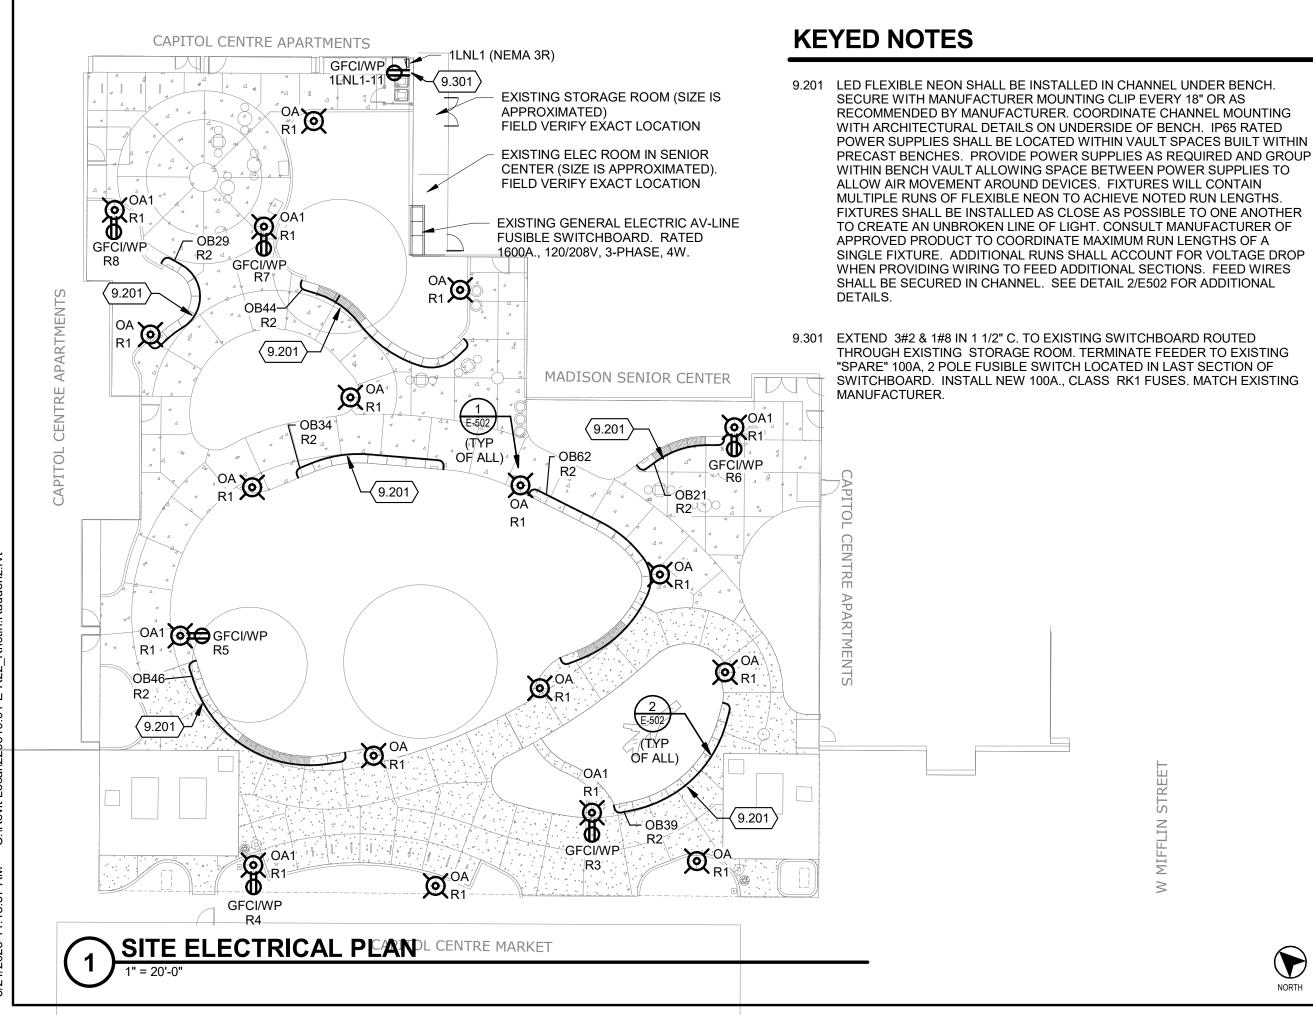
ELECTRICAL NOTES, SYMBOLS & ABBREVIATIONS

| SCALE | | DATE | |
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CITY OF MADISON PARKS DIVISION

330 E. LAKESIDE STREET MADISON, WI 53715

PROJECT

MADISON SENIOR CENTER COURTYARD

330 WEST MIFFLIN STREET MADISON, WI 53703

DRAWING

ELECTRICAL SITE PLAN

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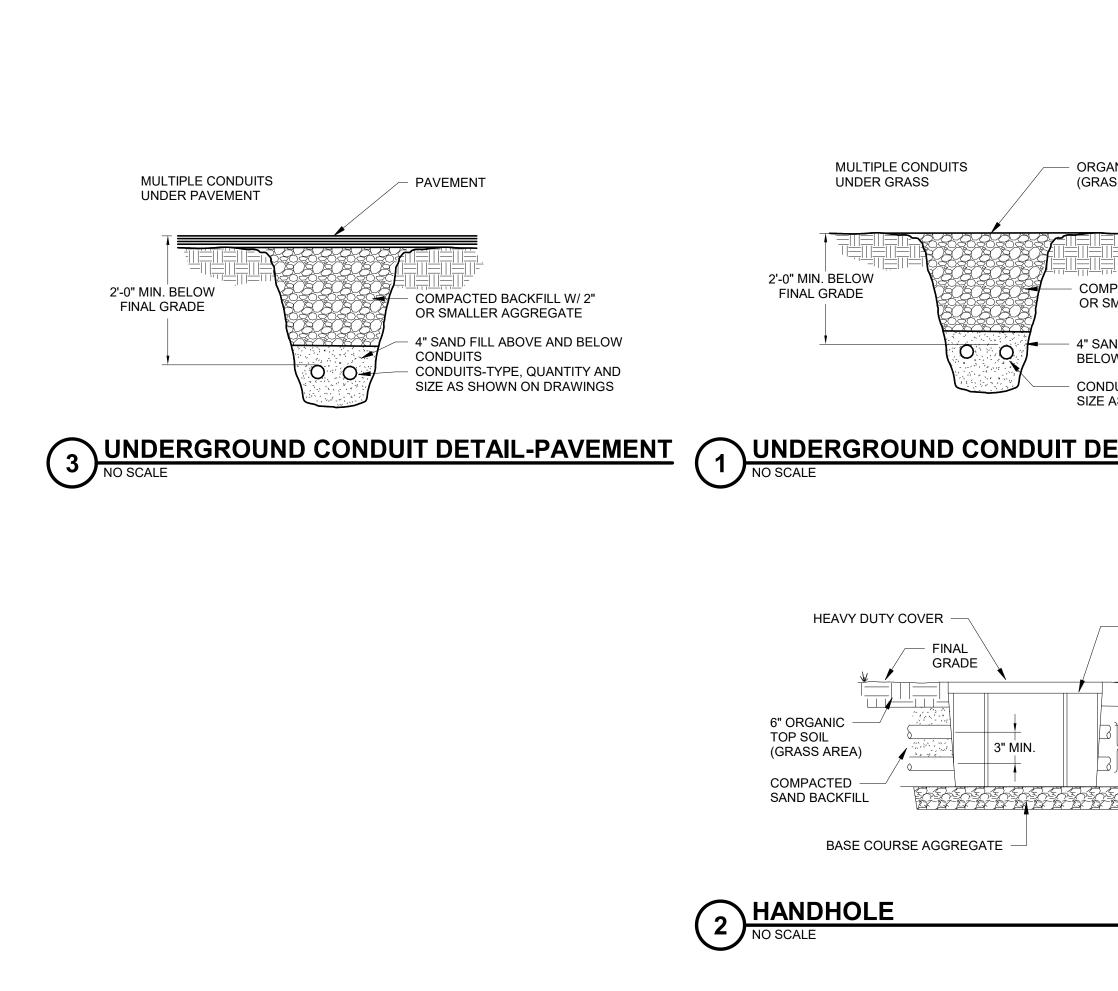
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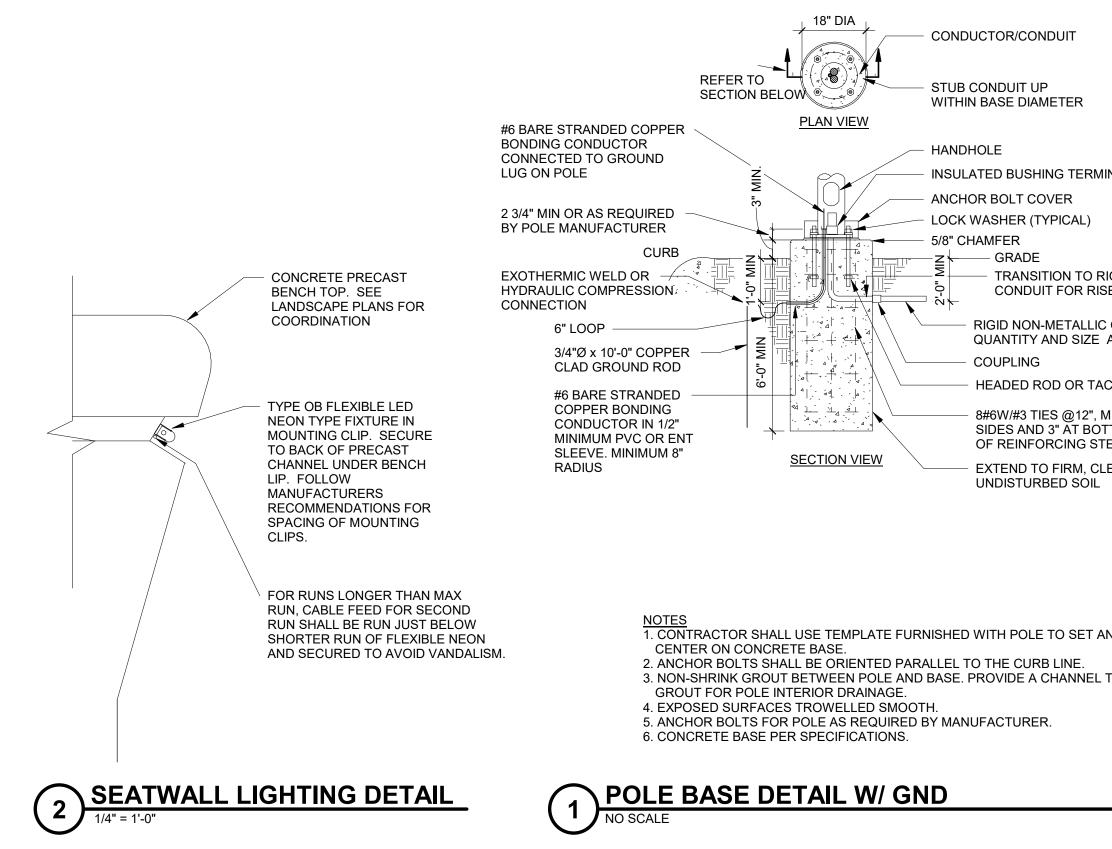
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| LUMINAIRE SCHEDULE | | | | | | | | | | | | |
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| DES | MANUFACTURER | CATALOG NUMBER | DESCRIPTION | LED DATA | VOLTAGE | MOUNTING | DRIVER TYPE | FIXTURE DEPTH | INPUT LOAD | LUMENS | ACCEPTACLE MANUFACTURERS | KEYED NOTES |
| OA | | MST-DG-1-MP350-30-10'-BK -UNV-HL50 | LOW GLARE, DARK SKY LED POST TOP ON 10' POST WITH HI/LOW 50% DIM | LED, 3000K | 120 V | POST TOP | F | 26" | 33 VA | 2965 | LITHONIA RADEAN | 2,3 |
| OA1 | SELUX | MST-DG-1-MP350-30-10'-BK -UNV-HL50-REC2 | LOW GLARE, DARK SKY LED POST TOP ON 10' POST WITH HI/LOW 50% DIM AND POST MOUNTED RECEPTACLE WITH LOCKING COVER | LED, 3000K | 120 V | POST TOP | F | 26" | 33 VA | 2965 | LITHONIA RADEAN | 2,3,4 |
| OB21 | | VARIOLED FLEX VENUS TC-3D-W930-*SEE PLANS-IP67 | 21' LONG LED 3D BENDING SILICONE ENCASED FLEXIBLE LINEAR LED | LED, 3000K | 120 V | SPECIAL | D | 5/8" | 60 VA | 100LM/FT | KLUS, OMNILIGHT | 1,2 |
| OB29 | | VARIOLED FLEX VENUS TC-3D-W930-*SEE PLANS-IP67 | 29'-8" LONG LED 3D BENDING SILICONE ENCASED FLEXIBLE LINEAR LED | LED, 3000K | 120 V | SPECIAL | D | 5/8" | 96 VA | 100LM/FT | KLUS, OMNILIGHT | 1,2 |
| OB34 | | VARIOLED FLEX VENUS TC-3D-W930-*SEE PLANS-IP67 | 34' LONG LED 3D BENDING SILICONE ENCASED FLEXIBLE LINEAR LED | LED, 3000K | 120 V | SPECIAL | D | 5/8" | 96 VA | 100LM/FT | KLUS, OMNILIGHT | 1,2 |
| OB39 | | VARIOLED FLEX VENUS TC-3D-W930-*SEE PLANS-IP67 | 39' LONG LED 3D BENDING SILICONE ENCASED FLEXIBLE LINEAR LED | LED, 3000K | 120 V | SPECIAL | D | 5/8" | 96 VA | 100LM/FT | KLUS, OMNILIGHT | 1,2 |
| OB44 | | | 44' 10" LONG 3D SIDE BENDING SILICONE ENCASED FLEXIBLE LINEAR LED | LED, 3000K | 120 V | SPECIAL | D | 5/8" | 120 VA | 100LM/FT | KLUS, OMNILIGHT | 1,2,5 |
| OB46 | | VARIOLED FLEX VENUS TC-3D-W930-*SEE PLANS-IP67 | 46' LONG LED 3D BENDING SILICONE ENCASED FLEXIBLE LINEAR LED | LED, 3000K | 120 V | SPECIAL | D | 5/8" | 120 VA | 100LM/FT | KLUS, OMNILIGHT | 1,2,5 |
| OB62 | | VARIOLED FLEX VENUS TC-3D-W930-*SEE PLANS-IP67 | 62' LONG LED 3D BENDING SILICONE ENCASED FLEXIBLE LINEAR LED | LED, 3000K | 120 V | SPECIAL | D | 5/8" | 156 VA | 100LM/FT | KLUS, OMNILIGHT | 1,2,5 |

DRIVER: (SEE SPECIFICATIONS)

- LED DIMMABLE DRIVER (0-10V) 10% DIM Α
- В LED DIMMABLE DRIVER (0-10V) - 1% DIM
- LED DIMMABLE DRIVER (ELV) С
- D LED NON-DIMMABLE DRIVER
- Е EMERGENCY DRIVER
- LED STEP-DIMMING DRIVER F

LUMINAIRE SCHEDULE GENERAL NOTES:

- 1. REFER TO DIVISION 26 SPECIFICATION FOR ADDITIONAL INFORMATION BEFORE ORDERING.
- 2. ALL LED LUMINAIRES MUST COMPLY WITH LM-79 AND LM-80 TESTING STANDARDS. L70 LIFE SHALL HAVE A MINIMUM OF 50,000 HOURS.
- 3. ANY PROPOSED SUBSTITUTIONS MUST BE SUBMITTED WITH PHOTOMETRIC CALCULATIONS AND CATALOG SHEETS WITH DATA TO PROVE EQUAL CHARACTERISTICS. PROVIDE PHYSICAL SAMPLES OF PROPOSED SUBSTITUTIONS UPON REQUEST.

LUMINAIRE SCHEDULE KEYED NOTES:

- 1. LED FLEXIBLE NEON FIXTURE. COORDINATE EXACT LENGTH REQUIRED WI BENCH DETAILS. POWER SUPPLIES ARE REMOTE AND SHALL BE IP65 RATEI PROVIDE POWER SUPPLIES AS REQUIRED AND SIZE ACCORDING TO POWER ASSOCIATED RUN. LOCATE POWER SUPPLIES WITHIN VAULT SPACE PROVI IN THE BENCH. PROVIDE WITH MOUNTING CLIPS AND SUPPORT FIXTURE AS RECOMMENDED BY MANUFACTURER.
- 2. WET LOCATION LISTED.
- 3. PROVIDE WITH 10' TALL ROUND STRAIGHT ALUMINUM POLE AND OPTIONAL BASE COVER. FINISH SHALL MATCH FINAL FIXTURE FINISH SELECTION.
- 4. PROVIDE WITH POLE MOUNTED GFCI RECEPTACLE AND WEATHER PROOF COVER. SEE PLANS FOR COORDINATION.
- 5. LED FLEXIBLE NEON LENGTHS THAT EXCEED THE MAXIMUM RUN LENGTH A SPECIFIED BY THE MANUFACTURER SHALL HAVE MULTIPLE LENGTHS MOUN IN LINE TO CREATE AN UNBROKEN LINE OF LIGHT. THE LEAD WIRE TO THE SECONDARY RUN(S) SHALL BE RUN ADJACENT TO THE INITIAL RUN IN THE CHANNEL AND SECURED TO AVOID DAMAGE. THE SECONDARY RUNS SHALL HAVE FEED WIRES SIZED ACCORDING TO VOLTAGE DROP RECOMMENDATIONS FROM MANUFACTURER. COORDINATE EXACT LENGTH REQUIRED WITH BENCH DETAILS. PROVIDE SHOP DRAWINGS FROM MANUFACTURER THAT SHOW ENTIRE RUN OF MULTIPLE LENGTHS, FEEDS, AND LEAD WIRES FOR A COMPLETE INSTALLATION.

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CITY OF MADISON PARKS DIVISION

330 E. LAKESIDE STREET MADISON, WI 53715

PROJECT

MADISON SENIOR CENTER COURTYARD

330 WEST MIFFLIN STREET MADISON, WI 53703

DRAWING

ELECTRICAL SCHEDULES

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| LIGHTING RELAY SCHEDULE | | | | | | | | | |
|-------------------------|---------|-------|-------|-------------------|------------------------------------|-----------------------------------|--------------------------------|----------------|--|
| RELAY NUMBER | VOLTAGE | POLES | PANEL | CIRCUIT NUMBER | LOAD LOCATION (ROOM NAME & NUMBER) | LOW VOLTAGE AUTOMATIC OVERRIDE | LOW VOLTAGE MANUAL OVERRIDE | KEYED NOTES | |
| R1 | 120 V | 1 | 1LNL1 | 1 | POST TOP LIGHTING COURTYARD | T1 | SOFTWARE | | |
| R2 | 120 V | 1 | 1LNL1 | 3 | BENCH LIGHTS COURTYARD | T2 | SOFTWARE | | |
| R3 | 120 V | 1 | 1LNL1 | 5 | SOUTHEAST POST RECEPTACLE | Т3 | SOFTWARE | | |
| R4 | 120 V | 1 | 1LNL1 | 7 | SOUTHWEST POST RECEPTACLE | Т3 | SOFTWARE | | |
| R5 | 120 V | 1 | 1LNL1 | 9 | WEST POST RECEPTACLE | Т3 | SOFTWARE | | |
| R6 | 120 V | 1 | 1LNL1 | 2 | EAST POST RECEPTACLE | Т3 | SOFTWARE | | |
| R7 | 120 V | 1 | 1LNL1 | 4 | NORTHEAST POST RECEPTACLE | T3 | SOFTWARE | | |
| R8 | 120 V | 1 | 1LNL1 | 6 | NORTHWEST POST RECEPTACLE | Т3 | SOFTWARE | | |

RELAY SCHEDULE GENERAL NOTES:

- 1. ALL TIMECLOCK SETTINGS MUST BE CONFIRMED WITH OWNER PRIOR TO ENGAGING FACTORY PROGRAMMING.
- 2. PROVIDE BARRIERS OR INDIVIDUAL PANELS AS NECESSARY TO SEPARATE VOLTAGES AND BRANCHES OF POWER.
- 3. PROVIDE CAPACITY FOR 25% SPARE RELAYS FOR FUTURE EXPANSION WITH A MINIMUM OF 2 SPACE RELAYS/ROOM CONTROLLERS PER LIGHTING CONTROL PANEL.

OVERRIDE DEFINITIONS:

SOFTWARE = CONTROLLED ONLY FROM AUTOMATIC CONTROL AND LIGHTING CONTROL SOFTWARE

T* = TIMECLOCK CONTROL

LOW VOLTAGE AUTOMATIC CONTROL **SETTINGS**:

- T1 AUTOMATIC TIME CONTROL WITH AUTOMATIC DAYLIGHT OVERRIDE -(ON 100%) DUSK / (DIM 50%) 10PM.
- T2 AUTOMATIC TIME CONTROL (ON 100%) DUSK / (OFF) 10PM.
- T3 EXTERIOR TIME CONTROL (ON) 24-7

LIGHTING CONTROL INTENT:

PROVIDE SMALL CENTRALIZED LOW VOLTAGE RELAY PANEL. nLIGHT ARP 8-RELAY OR SIMILAR WITH TIMECLOCK FUNCTION OR PROVIDE DISTRIBUTED RELAYS WITH TIMECLOCK IN HEAD END PANEL.

PANEL LOCATION SHALL BE UP HIGH ON WALL IN STORAGE CLOSET OR ELECTRICAL ROOM IN SENIOR CENTER. IF LOCATED IN STORAGE CLOSET, DISTRIBUTED RELAYS ARE PREFERRED TO KEEP ALL DEVICES HIGH AND OUT OF THE WAY OF POTENTIAL DAMAGE.

SOFTWARE MUST BE PROVIDED WITH LIGHTING CONTROL SYSTEM FOR MAINTENANCE AND SCHEDULING PURPOSES. OWNER TRAINING UPON COMPLETION OF LIGHTING CONTROL COMMISSIONING SHALL BE PROVIDED.

SWITCH LABELING INTENT:

• (R#) INDICATES CENTRALIZED LOW VOLTAGE RELAY CONTROL WHERE THE NUMBER IS THE CORRESPONDING RELAY

CONTROL INTENT BY SPACE:

EXTERIOR LIGHTING:

- PROVIDE LOW VOLTAGE LIGHTING CONTROL WITH STEP DIM POWER SUPPLY FOR DIMMING TO 50% OF ALL POLE MOUNTED AREA LIGHTING. LIGHTING SHALL TURN ON AT DUSK AND DIM TO 50% AT 10PM. LIGHTING WILL TURN OFF AT DAWN.
- PROVIDE LOW VOLTAGE LIGHTING CONTROL FOR ON/OFF RELAY CONTROL OF ALL UNDER BENCH LIGHTING. LIGHTING SHALL TURN ON AT DUSK AND OFF AT 10PM (PARK CLOSING).
- PROVIDE LOW VOLTAGE ON/OFF CONTROL FOR RECEPTACLES ON POLES. POWER SHALL BE ON 24/7 UNLESS DETERMINED OTHERWISE BY OWNER.

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| | Bus Ampacity | 1 | 100 | Volts | 208/120 | Panel Sou | rce: | SWBD | | | | |
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| | Branch Brkr Space | 18 | Poles | Phase | 1 | | Feed-Thru Lugs | | None | | | |
| | Main Type | MCB | | Wires 3 | | | | | | | | |
| | MCB Amps | 1 | 100 Delta/Wy | | - | Sub-Feed L | Sub-Feed Lugs | | None | | | |
| | · | | | Mounting | Surface | | U | | | | | |
| | | | | Enclosure | NEMA 3R | Sub-Feed B | 3rkr #1 | None | | | | |
| | | | | SCCR | 10 kA | | | | | | | |
| | | | | SE Rated | No | Sub-Feed B | 3rkr #2 | None | | | | |
| | | | | Pnl MCA | 18 A | | | | | | | |
| | Comments: | | | = | | | SPD | | | | | |
| | | | | | | | Iso Grd | No | | | | |
| Key | Load | Cct | Brkr | | Left Side | | Right Side | ė | Brkr | Cct | Load | Ke |
| Note | Description | No | A/P | Α | B | Α | B | - | A/P | No | Description | No |
| | POST TOP LTS | 1 | 20/1 | 650 | | 180 | - | — | 20/1 | 2 | RECEPT | |
| | UNDER BENCH LIGHTS | 3 | 20/1 | + + | 1,400 | | 180 | — | 20/1 | 4 | RECEPT | - |
| | RECEPT | 5 | 20/1 | 180 | | 180 | | | 20/1 | 6 | RECEPT | |
| | RECEPT | 7 | 20/1 | + + | 180 | | 0 | | | 8 | | |
| | RECEPT | 9 | 20/1 | 180 | | 0 | | _ | | 10 | | |
| | RECEPT | 11 | 20/1 | † | 180 | | 0 | | | 12 | | |
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